ALL SOIL EROSION AND SEDIMENT CONTROL PRACTICES TO BE INSTALLED PRIOR TO ANY MAJOR SOIL DISTURBANCE, OR IN THEIR PROPER SEQUENCE, AND MAINTAINED UNTIL PERMANENT PROTECTION IS

ANY DISTURBED AREAS THAT WILL BE LEFT EXPOSED MORE THAN I WORKDAY, AND NOT SUBJECT TO CONSTRUCTION TRAFFIC, WILL IMMEDIATELY RECEIVE A TEMPORARY SEEDING. IF THE SEASON PREVENTS THE ESTABLISHMENT OF A TEMPORARY COVER, THE DISTURBED AREAS WILL BE MULCHED WITH STRAW, OR EQUIVALENT MATERIAL, AT A RATE OF 2 TONS PER ACRE, ACCORDING TO STATE

PERMANENT VEGETATION TO BE SEEDED OR SODDED ON ALL EXPOSED AREAS WITHIN I DAY AFTER FINAL GRADING. MULCH TO BE USED AS NECESSARY FOR PROTECTION UNTIL SEEDING IS

ALL WORK IS TO BE DONE IN ACCORDANCE WITH THE STANDARDS FOR

A SUB-BASE COURSE WILL BE APPLIED IMMEDIATELY FOLLOWING ROUGH GRADING AND INSTALLATION OF IMPROVEMENTS IN ORDER TO STABILIZE STREETS, ROADS, DRIVEWAYS AND PARKING AREAS. IN AREAS WHERE NO UTILITIES ARE PRESENT, THE SUB-BASE SHALL BE INSTALLED WITHIN I DAY OF THE PRELIMINARY GRADING.

AT THE TIME WHEN THE SITE PREPARATION FOR PERMANENT VEGETATIVE STABILIZATION IS GOING TO BE ACCOMPLISHED, ANY SOIL THAT WILL NOT PROVIDE A SUITABLE ENVIRONMENT TO SUPPORT ADEQUATE VEGETATIVE GROUND COVER, SHALL BE REMOVED OR TREATED IN A WAY THAT WILL PERMANENTLY ADJUST THE CONDITIONS AND RENDER IT SUITABLE FOR VEGETATIVE GROUND COVER. IF THE REMOVAL OR TREATMENT OF THE SOIL WILL NOT PROVIDE SUITABLE CONDITIONS, NON-VEGETATIVE MEANS OF PERMANENT GROUND STABILIZATION WILL HAVE TO BE EMPLOYED.

- 2. AREA OF DISTURBANCE: 15,934 S.F.
- 3. NO STORMWATER DISCHARGES ARE SHOWN ON THE PLAN.
- 6. INSPECTIONS TO BE PERFORMED EACH WEEK AND AFTER 1/2" OF

STABILIZE ENTIRE PILE WITH VEGETATION OR COVER SILT FENCE

MIN. SLOPE

- I ALL ITEMS SHOWN ABOVE ARE INCIDENTAL TO SILT FENCE DETAIL UNLESS OTHERWISE NOTED, INCLUDING PERIODIC MAINTENANCE AND INSPECTION FOLLOWING RAIN EVENTS.
- 2 AREA CHOSEN FOR STOCKPILING OPERATIONS SHALL BE STABLE.
- 3 MAXIMUM SLOPE OF STOCKPILE SHALL BE 1:2.
- 4 UPON COMPLETION OF SOIL STOCKPILING, EACH PILE SHALL BE SURROUNDED WITH EITHER SILT FENCING AND THEN STABILIZED WITH VEGETATION OR COVERED.

## SEQUENCE OF SITE CONSTRUCTION:

INSTALL STABILIZED CONSTRUCTION ENTRANCE.

CLEAR AND REMOVE BRUSH WITHIN LIMITS OF DISTURBANCE ONLY.

CONSTRUCT SILT FENCE.

STRIP AND STOCKPILE TOPSOIL IF NECESSARY.

APPLY TEMPORARY SEEDING MIXTURE TO ALL EXCAYATED AREAS OF THE SITE AS REQUIRED AT THE END OF EACH OF WORK DAY.

MULCH SEEDED AREAS AS REQUIRED AT THE END OF EACH WORK DAY.

CONSTRUCT AGGREGATE BASE COURSE.

INSTALL STONE SURFACE COURSE.

REMOVE SILT FENCES, APPLY PERMANENT SEEDING MIXTURE.

CONTACT CHARLES MAY AT 845/896-2747, OR CONCERNING COMPLIANCE WITH THE IMPLEMENTATION OF SOIL AND EROSION CONTROL DEVICES.

ADDITIONAL EROSION AND SEDIMENT CONTROL MEASURES SHALL BE INSTALLED AS REQUIRED BY WAPPINGER FALLS CODE ENFORCEMENT OFFICER.

MIDDLEBUSH ROAD MUST BE KEPT CLEAN AT ALL TIMES.

WOVEN WIRE FENCE--WOVEN WIRE FENCE (MIN 14-1/2 GA., MAX. 6" MESH SPACING) (MIN 14-1/2 GA., MAX. 6' MESH -36' MIN. FENCE POSTS, SPACING), WITH FILTER FENCE POST DRIVEN MIN. 16' CLOTH OVER 20" MIN. HEIGHT OF FILTER FLOW -UNDISTURBED GROUND EMBED FILTER CLOTH MIN. 6" INTO GROUND PERSPECTIVE VIEW SECTION CONSTRUCTION SPECIFICATIONS

WOVEN WIRE FENCE TO BE FASTENED SECURELY TO FENCE POSTS WITH WIRE TIES OR STAPLES.

AT TOP AND MID SECTION. 3. WHEN TWO SECTIONS OF FILTER CLOTH ADJOIN EACH OTHER THEY SHALL BE OVERLAPPED BY SIX INCHES AND FOLDED.


2. FILTER CLOTH TO BE FASTENED SECURELY TO WOVEN WIRE FENCE WITH TIES SPACED EVERY 24"

4. MAINTENANCE SHALL BE PERFORMED AS NEEDED AND MATERIAL REMOVED WHEN "BULGES" DEVELOP IN THE SILT FENCE.

> POSTS: STEEL EITHER 'T' OR 'U' TYPE OR 2' HARDWOOD FENCE: WOVEN WIRE, 14-1/2 GA., 6" MAX. MESH OPENINGS

FILTER CLOTH: FILTER X, MIRAFI 100X, STABILINKA T140N, OR APPROVED EQUAL

PREFABRICATED UNIT: GEOFAB, ENVIROFENCE, OR APPROVED EQUAL

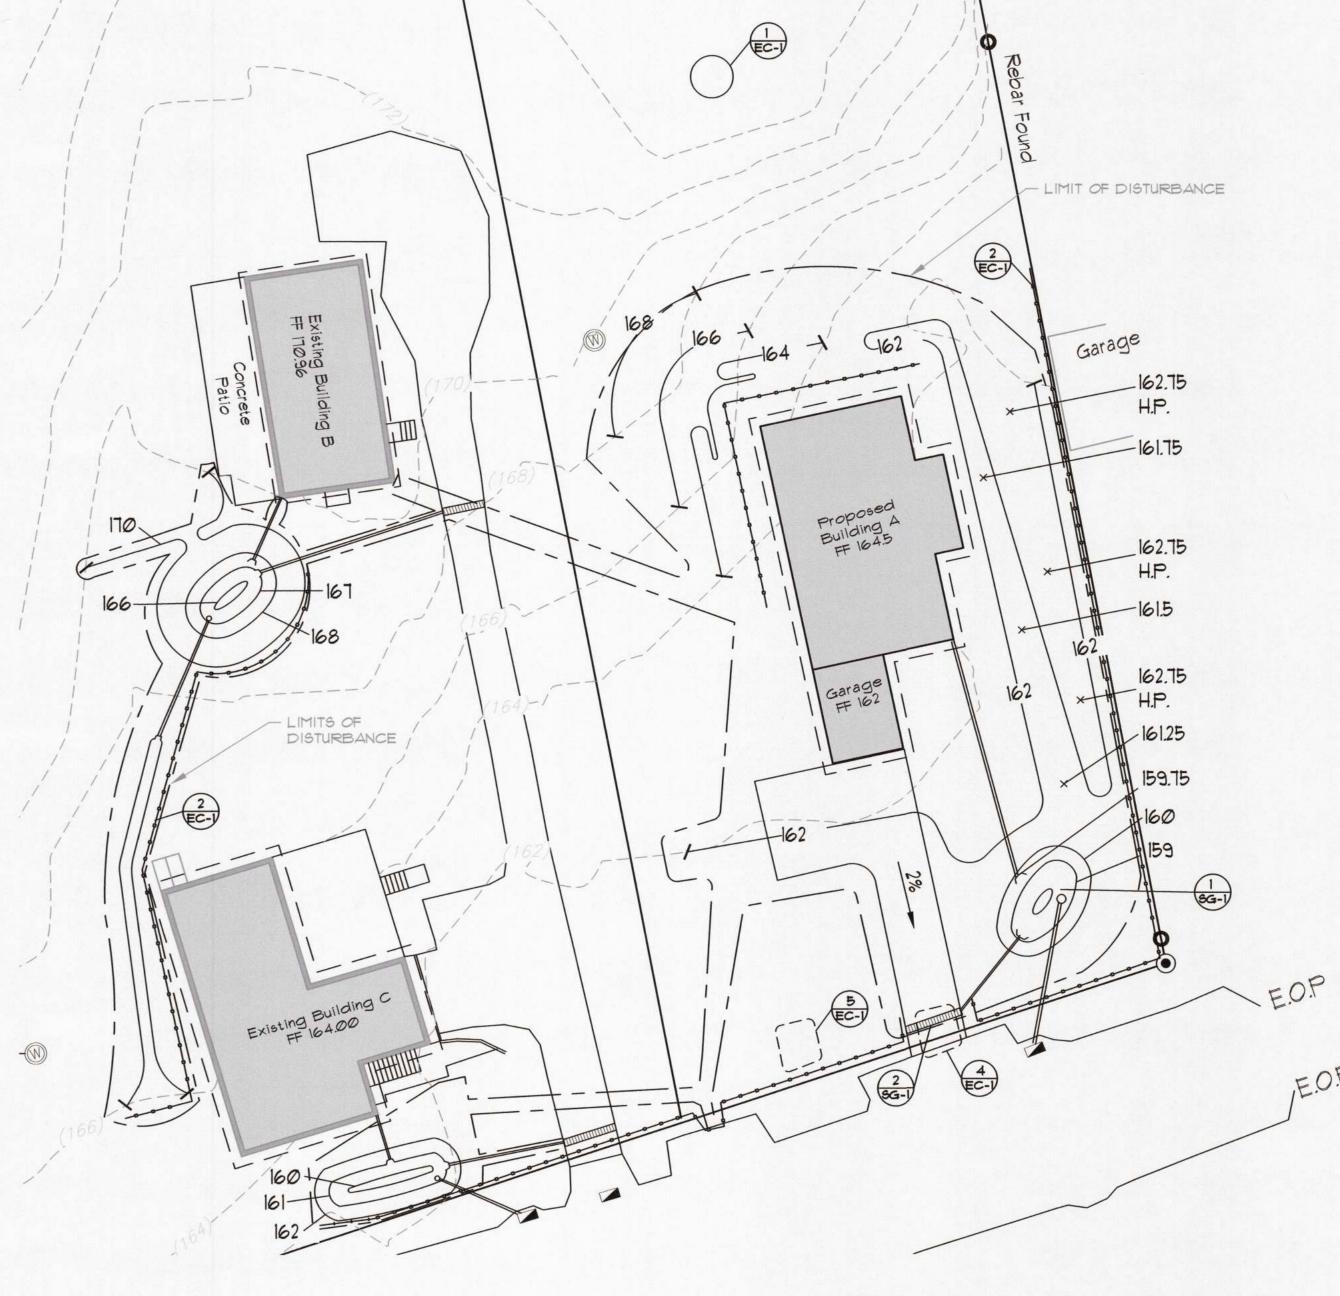

SEED MIXTURE

35% FINE-LEAFED RYEGRASS

15% KENTUCKY BLUEGRASS

9% ANNUAL RYEGRASS

6% WHITE CLOVER

400 SQ. FT


PER LB.

DENOTES AREAS TO BE SEEDED

IMMEDIATELY UPON COMPLETION

OF CONSTRUCTION ACTIVITY

35% FINE FESCUE

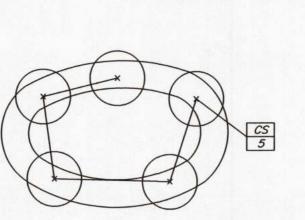

STATE LAW PROHIBITS ANY PERSON FROM ALTERING ANYTHING ON THIS DRAWING AND/OR THE ACCOMPANYING SPECIFICATION. UNLESS IT IS UNDER THE DIRECTION OF A LICENSED PROFESSIONAL. WHERE SUCH ALTERATIONS ARE MADE THE LICENSED PROFESSIONAL MUST SIGN, SEAL, DATE, AND DESCRIBE THE FULL EXTENT OF THE ALTERATION ON THE DRAWING AND/OR IN THE SPECIFICATION.

SCALE: 1" =20'-0'

PROFILE -MOUNTABLE BERM (OPTIONAL) FILTER CLOTH 100' MIN. XXXXX EXIST. 12' MIN PAVEMENT 24' MIN.

PAVEMENT


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DRAWN CHECKED CPM 11-13-23 JDC SCALE: |' = 20'-0' SHEET TITLE EROSION



## SOIL EROSION & SEDIMENT CONTROL NOTES:

ESTABLISHED.

STANDARDS.

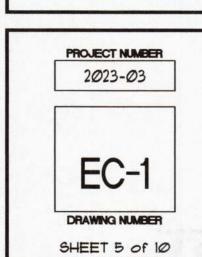ESTABLISHED.

SOIL EROSION AND SEDIMENT CONTROL IN NEW YORK.

IMMEDIATELY FOLLOWING INITIAL DISTURBANCE OR ROUGH GRADING, ALL CRITICAL AREAS SUBJECT TO EROSION WILL RECEIVE A TEMPORARY SEEDING IN COMBINATION WITH STRAW MULCH OR A SUITABLE EQUIVALENT, AT A RATE OF 2 TONS PER ACRE, ACCORDING TO STATE STANDARDS.

IN ACCORDANCE WITH THE STANDARD FOR PERMANENT VEGETATIVE COVER FOR SOIL STABILIZATION, ANY SOIL HAVING A Ph OF 4 OR LESS OR CONTAINING IRON SULFIDES SHALL BE COVERED WITH A MINIMUM OF 12 INCHES OF SOIL HAVING A Ph OF 5 OR MORE, AND NO IRON SULFIDE PRIOR TO SEEDBED PREPARATION.

TOTAL SITE AREA: 11,686 S.F.


4. DURING CONSTRUCTION A GARBAGE DUMPSTER WILL BE ON THE SITE AND CLEAN UP WILL BE CONDUCTED AT THE END OF EACH WORK

5. SOIL DESCRIPTION: DWB (DUTCHESS-CARDIGAN COMPLEX, UNDULATING, ROCKY) 100%

RAINFALL BY A QUALIFIED LICENSED PROFESSIONAL ENGINEER OR REGISTERED LANDSCAPE ARCHITECT.

## CONSTRUCTION SPECIFICATIONS

- STONE SIZE USE 2" STONE, OR RECLAIMED OR RECYCLED CONCRETE EQUIVALENT.
- LENGTH NOT LESS THAN 100 FEET.
- THICKNESS NOT LESS THAN SIX (6) INCHES
- WIDTH TWENTY-FIVE (25) FOOT MINIMUM, BUT NOT LESS THAN THE FULL WIDTH AT POINTS WHERE INGRESS OR EGRESS OCCURS.
- FILTER CLOTH WILL BE PLACED OVER THE ENTIRE AREA PRIOR TO PLACING OF STONE. SURFACE WATER - ALL SURFACE WATER FLOWING OR DIVERTED TOWARDS CONSTRUCTION ENTRANCES SHALL BE PIPED ACROSS THE ENTRANCE. IF PIPING IS IMPRACTICAL, A MOUNTABLE
- BERM WITH 5:1 SLOPES WILL BE PERMITTED. MAINTENANCE - THE ENTRANCE SHALL BE MAINTAINED IN A CONDITION WHICH WILL PREVENT TRACKING OR FLOWING OF SEDIMENT ONTO PUBLIC RIGHTS-OF-WAY. ALL SEDIMENT SPILLED, DROPPED, WASHED OR TRACTED ONTO PUBLIC RIGHTS-OF WAY MUST BE REMOVED IMMEDIATELY.
- WHEN WASHING IS REQUIRED, IT SHALL BE DONE ON AN AREA STABILIZED WITH STONE AND WHICH DRAINS INTO AN APPROVED SEDIMENT TRAPPING DEVICE.
- PERIODIC INSPECTION AND NEEDED MAINTENANCE SHALL BE PROVIDED AFTER EACH RAIN.
- AREA OF DISTURBANCE: 16,263 SQFT (.37 ACRES)

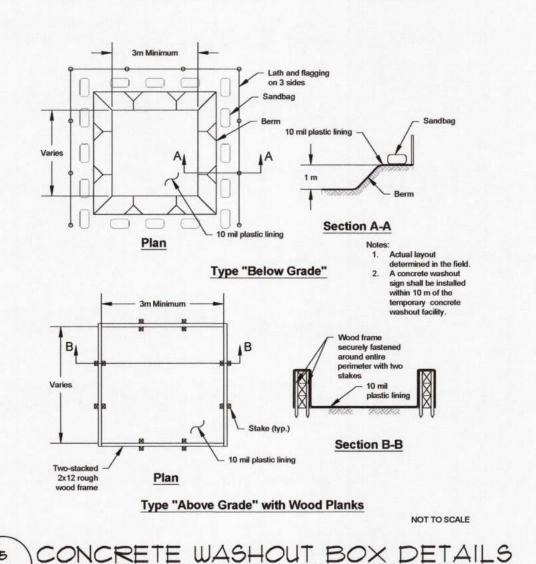

## NOTE:

· PLANT SHALL BE SET AT ORIGINAL DEPTH, ALL BINDING CUT, AND BURLAP REMOVED FROM TOP 1/3 OF ROOT BALL.

EXIST

GROUND

· TOPSOIL MIX SHALL CONSIST OF 4 PARTS TOPSOIL TO ONE PART PEAT WITH 5 LB. SUPERPHOSPHATE ADDED PER C.Y. OF MIXTURE. REMOVE ENOUGH WHOLE BRANCHES (NOT END TIPS) TO REDUCE FOLIAGE BY 1/3 3"-6" MIN. DEPTH MULCH 3" SAUCER PREVIOUSLY EXISTING GRADE TOPSOIL MIXTURE 6" DEPTH COMPACTED TOPSOIL

SHRUB PLANTING DETAIL NOT TO SCALE

B4B 3'-5' CS 5 CORNUS STOLONIFERA RED-06IER DOGWOOD 121-151