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Neil J. Alexander, Esq. nalexander@cuddyfeder.com

November 1, 2019

By Email and Regular Mail

Chairperson Bruce Flower And Members of the Planning Board 20 Middlebush Road Wappingers Falls, NY 12590

-and-

Chairperson Al Casella And Members of the Zoning Board of Appeals 20 Middlebush Road Wappingers Falls, NY 12590

RE: Tarpon Towers II, LLC

Proposed Wireless Telecommunications Facility at 110 Chelsea Road Parcel # 6056-03-339420

Dear Chairperson Flower, Chairperson Casella, and Members of the Planning and Zoning Boards:

On behalf of our client, Tarpon Towers II, LLC (the "Applicant"), we respectfully submit the following in furtherance of the application for site plan, special permit, wetlands permit and area variance approvals to install a new wireless telecommunications facility (the "Facility") at 110 Chelsea Road in the Town of Wappinger, New York (the "Property"). Enclosed please find:

Exhibit A: FAA Certification, dated October 7, 2019

Exhibit B: RF Compliance Certification, dated October 31, 2019

Exhibit C: RF Non-interference Letter, dated October 15, 2019

Exhibit D: Revised Site Plans prepared by Tectonic Engineering & Surveying Consultants,

P.C., dated October 24, 20191

¹ Full size drawings can be provided upon request.



November 1, 2019 Page 2

Exhibit E: Agriculture Data Statement

Kindly also find enclosed two checks made payable to the Town of Wappinger in the amount of \$750 and \$150 representing the Zoning Board of Appeals area variance application fee and wetland permit application fee, respectively. A wetland permit application form and report in accordance with Chapter 137 will be provided shortly.

Thank you for your time and consideration in this matter. The Applicant looks forward to meeting with the Planning Board on November 4, 2019 and the Zoning Board of Appeals on November 12, 2019. Should you have any questions or comments in the meanwhile, please do not hesitate to contact me.

Very truly yours,

Neil J. Alexander


Enclosures

cc: Barbara Roberti, CEO (via email)

James Horan, Esq., Town Attorney (via email)

David Stolman, Planner (via email) Peter Setaro, Engineer (via email)



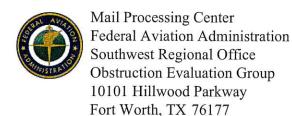

Aeronautical Study No. 2019-AEA-10474-OE Prior Study No. 2019-AEA-6208-OE

Issued Date: 10/07/2019

Todd J Bowman Tarpon Towers II, LLC 1001 3rd Avenue West Suite 420 Bradenton, FL 34205

** DETERMINATION OF NO HAZARD TO AIR NAVIGATION **

The Federal Aviation Administration has conducted an aeronautical study under the provisions of 49 U.S.C., Section 44718 and if applicable Title 14 of the Code of Federal Regulations, part 77, concerning:

Structure:

Tower NY1136 Castle Point

Location:

Wappinger Falls, NY 41-32-47.21N NAD 83

Latitude: Longitude:

73-57-22.57W

Heights:

175 feet site elevation (SE)

199 feet above ground level (AGL) 374 feet above mean sea level (AMSL)

This aeronautical study revealed that the structure does not exceed obstruction standards and would not be a hazard to air navigation provided the following condition(s), if any, is(are) met:

It is required that FAA Form 7460-2, Notice of Actual Construction or Alteration, be e-filed any time the project is abandoned or:

	At least 10 days prior to start of construction (7460-2, Part 1)
X	Within 5 days after the construction reaches its greatest height (7460-2, Part 2)

Based on this evaluation, marking and lighting are not necessary for aviation safety. However, if marking/lighting are accomplished on a voluntary basis, we recommend it be installed in accordance with FAA Advisory circular 70/7460-1 L Change 2.

This determination expires on 04/07/2021 unless:

- (a) the construction is started (not necessarily completed) and FAA Form 7460-2, Notice of Actual Construction or Alteration, is received by this office.
- (b) extended, revised, or terminated by the issuing office.
- (c) the construction is subject to the licensing authority of the Federal Communications Commission (FCC) and an application for a construction permit has been filed, as required by the FCC, within 6 months of the date of this determination. In such case, the determination expires on the date prescribed by the FCC for completion of construction, or the date the FCC denies the application.

NOTE: REQUEST FOR EXTENSION OF THE EFFECTIVE PERIOD OF THIS DETERMINATION MUST BE E-FILED AT LEAST 15 DAYS PRIOR TO THE EXPIRATION DATE. AFTER RE-EVALUATION OF CURRENT OPERATIONS IN THE AREA OF THE STRUCTURE TO DETERMINE THAT NO SIGNIFICANT AERONAUTICAL CHANGES HAVE OCCURRED, YOUR DETERMINATION MAY BE ELIGIBLE FOR ONE EXTENSION OF THE EFFECTIVE PERIOD.

This determination is based, in part, on the foregoing description which includes specific coordinates, heights, frequency(ies) and power. Any changes in coordinates, heights, and frequencies or use of greater power, except those frequencies specified in the Colo Void Clause Coalition; Antenna System Co-Location; Voluntary Best Practices, effective 21 Nov 2007, will void this determination. Any future construction or alteration, including increase to heights, power, or the addition of other transmitters, requires separate notice to the FAA. This determination includes all previously filed frequencies and power for this structure.

If construction or alteration is dismantled or destroyed, you must submit notice to the FAA within 5 days after the construction or alteration is dismantled or destroyed.

This determination does include temporary construction equipment such as cranes, derricks, etc., which may be used during actual construction of the structure. However, this equipment shall not exceed the overall heights as indicated above. Equipment which has a height greater than the studied structure requires separate notice to the FAA.

This determination concerns the effect of this structure on the safe and efficient use of navigable airspace by aircraft and does not relieve the sponsor of compliance responsibilities relating to any law, ordinance, or regulation of any Federal, State, or local government body.

A copy of this determination will be forwarded to the Federal Communications Commission (FCC) because the structure is subject to their licensing authority.

This determination cancels and supersedes prior determinations issued for this structure.

If we can be of further assistance, please contact our office at (404) 305-6337, or nick.goodly@faa.gov. On any future correspondence concerning this matter, please refer to Aeronautical Study Number 2019-AEA-10474-OE.

Signature Control No: 416824693-419122546

(DNE)

Nick Goodly Technician

Attachment(s)
Case Description
Frequency Data
Map(s)

cc: FCC


Case Description for ASN 2019-AEA-10474-OE

Construction of new communications tower. Location has shifted since prior ASN


Frequency Data for ASN 2019-AEA-10474-OE

LOW FREQUENCY	HIGH FREQUENCY	FREQUENCY UNIT	ERP	ERP UNIT
TREQUERTOR	TREQUERTOR	- 01(11	<u> </u>	
6	7	GHz	55	dBW
6	7	$_{ m GHz}$	42	dBW
10	11.7	GHz	55	dBW
10	11.7	GHz	42	dBW
17.7	19.7	GHz	55	dBW
17.7	19.7	GHz	42	dBW
21.2	23.6	GHz	55	dBW
21.2	23.6	GHz	42	dBW
614	698	MHz	1000	W
614	698	m MHz	2000	W
698	806	MHz	1000	W
806	901	MHz	500	W
806	824	MHz	500	W
824	849	MHz	500	W
851	866	MHz	500	W
869	894	MHz	500	W
896	901	MHz	500	W
901	902	MHz	7	\mathbf{W}
929	932	MHz	3500	W
930	931	MHz	3500	\mathbf{W}
931	932	$\mathbf{M}\mathbf{H}\mathbf{z}$	3500	\mathbf{W}
932	932.5	MHz	17	dBW
935	940	MHz	1000	\mathbf{W}^{-1}
940	941	MHz	3500	W
1670	1675	MHz	500	W
1710	1755	MHz	500	W
1850	1910	MHz	1640	\mathbf{W}
1850	1990	MHz	1640	W
1930	1990	MHz	1640	W
1990	2025	MHz	500	\mathbf{W}
2110	2200	MHz	500	\mathbf{W}
2305	2360	MHz	2000	W
2305	2310	MHz	2000	W
2345	2360	MHz	2000	W
2496	2690	MHz	500	W

Verified Map for ASN 2019-AEA-10474-OE

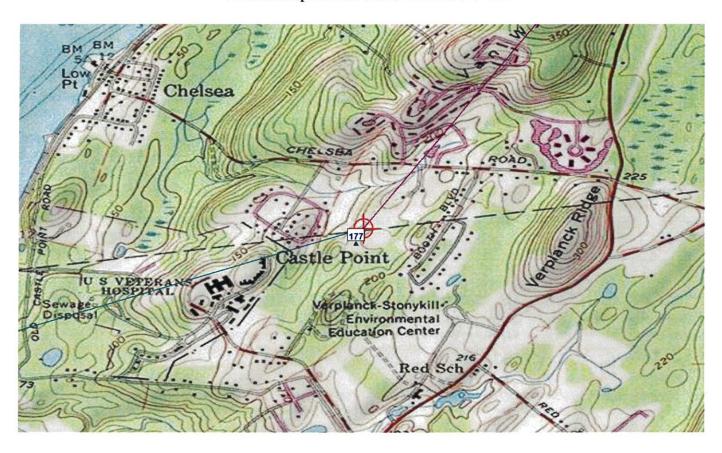

TOPO Map for ASN 2019-AEA-10474-OE

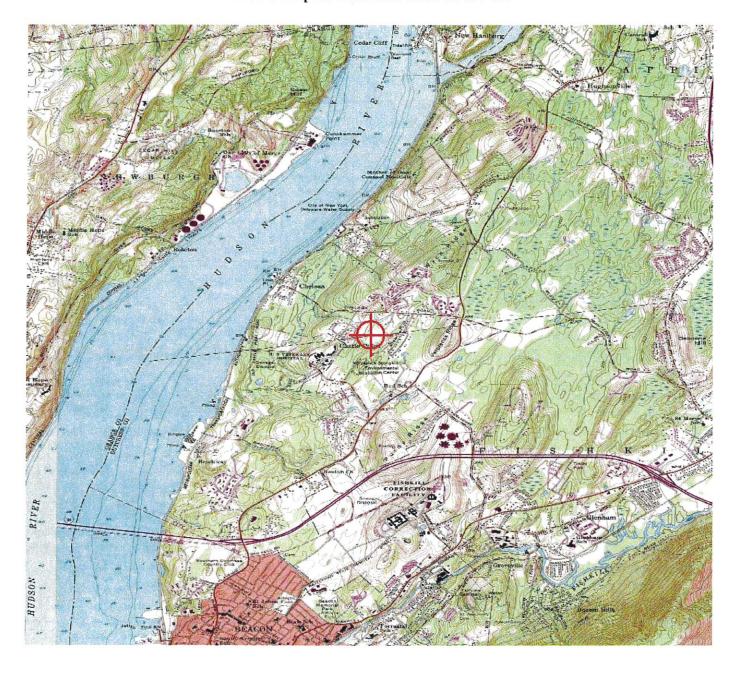





October 31, 2019

To: Michael Crosby

Transmitted via email to: Michael.Crosby2@VerizonWireless.com RE: Verizon Wireless – **Castle Point** RF Compliance Certification

Site Address: 110 Chelsea Road, Wappinger Falls, NY 12401 (Dutchess County)

To Whom It May Concern,

We write to inform you that Verizon Wireless has performed a radio frequency (RF) compliance pre-construction evaluation for the above-noted proposed site and based on the result of the evaluation, the site will be compliant with FCC Guidelines in all publicly accessible areas. With the proposed Verizon Wireless antenna configuration in service, the exposure in all areas at ground level from this facility will be below 1% of the General Public MPE limit, or over 100 times less than the maximum allowed exposure in publicly accessible areas. The information in this compliance document was prepared by Site Safe, LLC, an approved Verizon vendor.

The FCC has established safety rules relating to potential RF exposure from cell sites. The rules are codified at 47 C.F.R § 1.1310. The FCC provides guidance on how to ensure compliance with its rules in the FCC Office of Engineering and Technology Bulletin 65 (available at

https://transition.fcc.gov/Bureaus/Engineering Technology/Documents/bulletins/oet65/oet65.pdf). The FCC developed the RF standards, known as Maximum Permissible Exposure (MPE) limits, in consultation with numerous other federal agencies, including the Environmental Protection Agency, the Food and Drug Administration, and the Occupational Safety and Health Administration. The FCC provides information about the safety of radio frequency (RF) emissions from cell towers on its website at:

https://www.fcc.gov/engineering-technology/electromagnetic-compatibility-division/radio-frequency-safety/faq/rf-safety.

Please refer to the FCC Office of Engineering and Technology Bulletin 65 and the attached Verizon Wireless RF Brochure for information on RF exposure guidelines, RF safety, and landlord responsibilities.

Sincerely,

Michael Fischer, P.E. Principal RF Compliance Engineer Site Safe, LLC



Michael Fischer, P.E. Registered Professional Engineer (Electrical) New York License Number 101714 Expires July 31, 2022



Landlord Responsibilities (M.E.N.U)

RF exposure safety and protection of every carrier's infrastructure are very important. Both landlords and carriers have a shared responsibility in maintaining a safe and secure RF environment. Landlords can help in this significant endeavor by:

- Maintaining all necessary carrier contact information.
- Enforcing restricted roof-top access (help maintain a Controlled environment).
- Ensuring all building/maintenance personnel are trained in RF Safety, aware that the potential for exposure exists, and follow all appropriate entry and safety procedures.
- Notifying all carriers when any non-carrier requests access to the area with antennas.
- Understanding that compliance with the FCC can be achieved with RF Exposure levels above the applicable limit if the proper signage, barrier, and access restrictions are implemented. Commitment to compliance and willingness to cooperate are key.



FOR MORE INFORMATION OF

Verizon Wireless E-mail: npo@verizon-vireless.com E-mail Subject: "ATTN: RF Compliance"

RF Safety & Awareness Training Contacts

C-Squared Systems

(www.csquaredsystems.com)

EBI Consulting

(www.ebiconsulting.com)

Global RF Solutions

(www.grfs.net)

Hammett & Edison, Inc.

(www.h-e.com)

Lawrence Behr Associates, Inc.

(www.lbagroup.com)

Millennium Engineering

(www.millenniumengineering.net)

Pinnacle Telecom Group

(www.pinnacletelecomgroup.com)

Richard A. Tell Associates

(www.radhaz.com)

851

(www.rfcomply.com)

SiteSafe

(www.sitesafe.com)

Telnet

(www.telnet-inc.com)

Trott Communications Group

(www.trotteroup.com)

Waterford Consultants

(www.waterfordconsultants.com)

WEL

(www.wfinet.com)

Radio Frequency (RF) Environments

SAFETY & AWARENESS





FCC Information

The Federal Communications Commission (FCC) has established safety guidelines relating to RF exposure from cell sites. The FCC developed those standards, known as Maximum Permissible Exposure (MPE) limits, in consultation with numerous other federal agencies, including the Environmental Protection Agency, the Food and Drug Administration, and the Occupational Safety and Health Administration. The standards were developed by expert scientists and engineers after extensive reviews of the scientific literature related to RF biological effects. The FCC explains that its standards incorporate prudent margins of safety. The following represents an overview of the most applicable information:

Classifications for Exposure Limits

Occupational

Persons are "exposed as a consequence of their employment" and are "fully aware of the potential for exposure and can exercise control over their exposure".

General Population

Any persons that "may not be made fully aware of the potential for exposure or cannot exercise control over their exposure".

Those in this category do not have RF Safety & Awareness Training.

Ensuring Compliance With FCC Guidelines

Areas or portions of any transmitter site may be susceptible to high power densities that could cause personnel exposures in excess of the FCC guidelines.

Wireless Licensees are required by law to implement the following:

- Restrict access (lock doors/ladders)
- Post notification signage on every access point to increase awareness of the potential for exposure BEFORE one enters an area with antennas.
- Place additional notification signage and visual indicators in an area with antennas (beyond an access point) where RF exposure levels may start to exceed the FCC's limits.

Compliance Materials

Notification Signage



(Notice) RF Guidelines - Informs viewer of the basic safety guidelines for working in an RF Environment.

MATION CO.

Information – Provides relevant contact information for any questions or requests.



(Blue) Notice - Informs viewer that beyond the sign, RF exposure levels may exceed the General Population MPE limit but will remain below the Occupational MPE limit.



(Yellow) Caution - Informs viewer that beyond the sign, RF exposure levels may exceed the General Population and Occupational MPE limit.



(Red) Warning - Informs viewer that beyond the sign, RF exposure levels may substantially exceed the General Population and Occupational MPE limit.

Indicative Barriers

In addition to physical barriers such as locked doors or ladders, wireless licensees may also be required to place indicative barriers as a means of visually demarcating an area where RF levels are expected to exceed the FCC's limits. Examples of Indicative Barrier Materials: plastic chains, buckets, reflective paint or tape, plastic cones, fiberglass fences, and poles mounted in cinderblocks.



Antenna Safety

Antenna Types



Yagi - Antenna that radiates energy in one direction. RF energy has a narrow beam. Walk behind or under this antenna.



Panel - Antenna that radiates energy in one direction. RF energy beam can range from narrow to very wide. Walk behind this antenna. Stay out of the general direction that the antenna is pointing.




Whip - Antenna that radiates energy equally in all directions. Maintain as much distance as possible from this antenna.



Microwave - Antenna that radiates energy in one direction. RF energy has a narrow beam. Walk under or behind this antenna.

When In An Environment With Antennas:

- Maintain at least a 3-foot clearance from all antennas. A 10-foot separation distance is preferred.
- ⇒ Never touch an antenna. Assume all are active.
- ⇒ Read and obey ALL signs on an access point.
- ⇒ Read and obey ALL signs in the environment with antennas.
- Never walk past an indicative barrier without first confirming transmitter inactivity.
- Never walk in front of or stand in front of an antenna whenever possible. Keep walking.
- ⇒ Contact all wireless licensees at least 24hours in advance of scheduled maintenance.

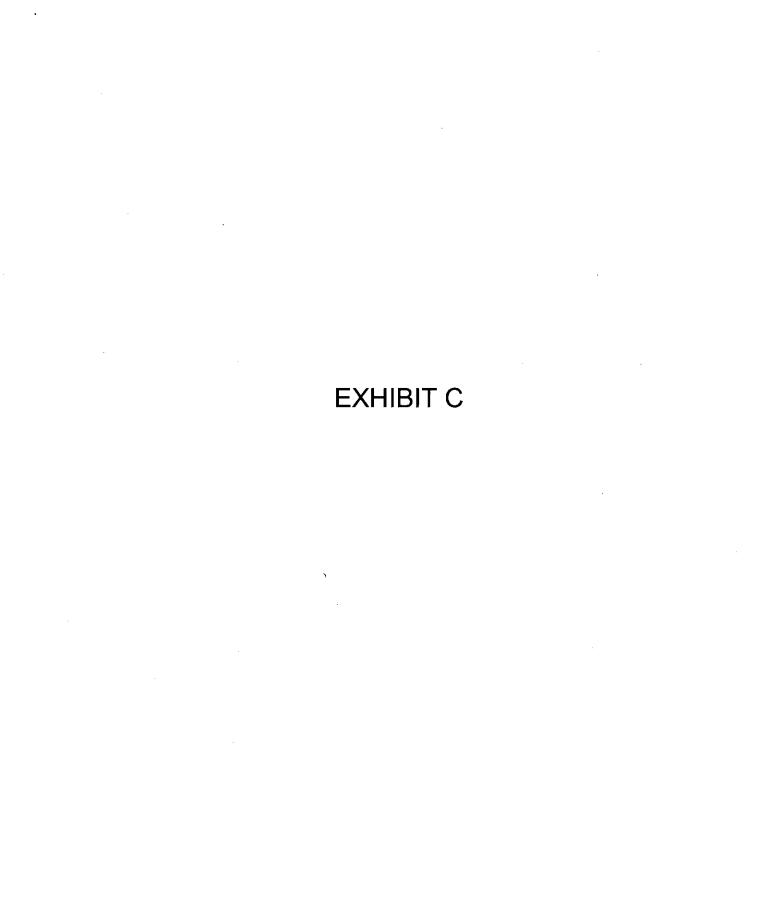



Network Engineering - UPNY 1275 John Street, Suite 100 West Henrietta, New York 14586

Oct 15, 2019

Planning Board Town of Wappinger 20 Middlebush Rd Wappinger Falls, NY 12590

RE: Castle Point Macro - Application of Verizon Wireless - Non-Interference Letter

Ladies and Gentlemen:

With respect to the above application, and in accordance with applicable provisions of the Wireless Telecommunications Facilities Siting Law for the **Town of Wappinger**, Verizon Wireless ("Verizon Wireless") operates Wireless Communications Forth Generation (4G) Services, Personal Communication Service (PCS) and/or Cellular Radiotelephone Services network authorized by the Federal Communications Commission (FCC) to provide state of the art digital and/or cellular wireless communications in many parts of the nation, including upstate New York. Verizon Wireless' operations and network are licensed and regulated by the FCC.

Verizon Wireless' radio equipment is designed to transmit frequencies only within the allocated frequency bands and each transmitter is carefully adjusted to comply with FCC regulations for power output and frequency. These procedures prevent interference with other radio services, public safety communications, airport navigation, cordless phones, computers and other community office or residential household appliances.

The incidence of these transmissions causing interference with other radio service is rare. All other radio communication services, including broadcast radio and television, are assigned to specific frequency bands, separate and distinct from cellular and other frequencies. For instance, AM Radio operates between 0.5 -1.5 MHz and VHF Television operates between 54 - 215 MHz. In addition, receivers for other services are similarly designed to prevent interference from out of band service. In the unlikely event that malfunctioning equipment or improper settings are shown to cause interference with an existing service, Verizon Wireless would be required, under the conditions of its FCC license, to take immediate steps to correct any problems.

Thank you for considering this application.


Very truly yours,

Michael R. Crosby

Michael R. Crosby Radio Frequency (RF) Design Engineer **EXHIBIT D**



SITE NUMBER: NY1136 SITE NAME: **CASTLE POINT**

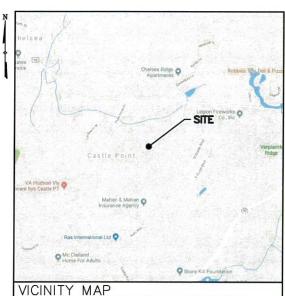

DIRECTIONS

FROM ALBANY, TAKE I-87 S AND FOLLOW FOR 82.4 \pm MILES. TAKE EXIT 17 TO MERGE ONTO I-84 E AND FOLLOW FOR 4.9 \pm MILES. TAKE EXIT 41 AND TURN LEFT ONTO NY-9D N AND FOLLOW FOR 2.9 \pm MILES. TURN LEFT ONTO CHELSEA RD AND FOLLOW FOR 0.5 \pm MILES. THE SITE WILL BE ON THE LEFT.

SITE ADDRESS: 110 CHELSEA RD WAPPINGERS FALLS, NY 12401 MUNICIPALITY: TOWN OF WAPPINGER COUNTY: DUTCHESS TAX MAP NUMBER: 6056-03-339420 ZONING DISTRICT: R-40/80 41.546447° -73.956270° GROUND ELEVATION: 174.7°± AMSL PROPERTY OWNER: RADICE, JEANNE M 110 CHELSEA RD WAPPINGERS FALLS, NY 12590 TARPON TOWERS II, LLC 1001 3RD AVE WEST, SUITE 420 BRADENTON, FL 34205 APPLICANT: CONTACT PERSON: CONTACT PHONE (941) 400-2202

PROJECT SUMMARY

PROJECT DESCRIPTION

THE PROPOSED WORK CONSISTS OF INSTALLING CELLULAR ANTENNAS AND RELATED EQUIPMENT ON A PROPOSED MONOPOLE AND THE INSTALLATION OF EQUIPMENT AT GRADE WITHIN A PROPOSED FENCED COMPOUND. PROJECT INCLUDES THE INSTALLATION OF A NEW GRAVEL ACCESS ROAD AND UNDERGROUND POWER & FIBER UTILITIES.

ORANGE COUNTY-POUGHKEEPSIE LIMITED PARTNERSHIP, d/b/a



PROJECT NUMBER: 20191970954 LOCATION CODE: 295486

SHT. NO.	DESCRIPTION	REV NO	REVISION DATE
T-1	TITLE SHEET	2	10/24/1
SU-101	PARTIAL TOPOGRAPHIC SURVEY	1	10/3/19
AD-1	ADJOINERS PLAN	2	10/24/1
SB-1	SETBACK PLAN	2	10/24/1
LOC-1	LOCATION MAP	2	10/24/1
VIC-1	VICINITY MAP	2	10/24/1
C-1	OVERALL SITE PLAN	2	10/24/19
C-2	ROAD PLAN & PROFILE	2	10/24/1
C-3	SITE DETAIL PLAN	2	10/24/1
C-4	ELEVATION & ORIENTATION PLAN	2	10/24/19
C-5	SITE DETAILS	2	10/24/19
C-6	SITE DETAILS	2	10/24/1
C-7	ANTENNA SPECIFICATIONS	2	10/24/1
C-8	EQUIPMENT ELEVATIONS	2	10/24/1
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1			
CLIE	ET INDEX		

THIS SET OF PLANS SHALL NOT BE UTILIZED AS CONSTRUCTION DOCUMENTS UNTIL ALL ITEMS OF CONCERN HAVE BEEN ADDRESSED AND EACH OF THE

DRAWINGS HAS BEEN REVISED AND ISSUED "FOR CONSTRUCTION"

Before You Dig, Drill Or Blast!

Dig Safely. New York

UNDERGROUND FACILITIES PROTECTIVE ORGANIZATION CALL US TOLL FREE 1-800-962-7962

DIG SAFELY - NEW YORK

NY industrial code rule 753 requires no less than two working days notice, but not more than ten days notice

DO NOT SCALE DRAWINGS

THESE DRAWINGS ARE FORMATTED FOR 22"x34" FULL SIZE AND 11"x17" HALF SIZE. OTHER SIZED VERSIONS ARE NOT PRINTED TO THE SCALE SHOWN. CONTRACTOR SHALL VERIFY ALL PLANS, EXISTING DIMENSIONS & CONDITIONS ON THE JOB SITE & SHALL IMMEDIATELY NOTIFY THE ENGINEER IN WRITING OF ANY DISCREPANCIES BEFORE PROCEEDING V THE WORK OR BE RESPONSIBLE FOR SAME.



1001 3RD AVE WEST, SUITE 420 BRADENTON, FL, 34205



1275 JOHN STREET, SUITE 100 WEST HENRIETTA, NY 14586



WOR	RK ORDER	NUMBER	DRAWN BY
968	4.06		TLS
NO.	DATE	ISSUE	
0	9/17/19	FOR COMME	ENT
1	10/3/19	FOR ZONING	3
2	10/24/19	PER COMME	INTS

RELEASED BY



NY1136 CASTLE POINT

VERIZON WIRELESS SITE INFORMATION CASTLE POINT RE PN: 20191970954

LC: 295486 SITE ADDRESS


110 CHELSEA RD TOWN OF WAPPINGER DUTCHESS COUNTY NY 12401

SHEET TITLE


TITLE SHEET

SHEET NUMBER

T-1

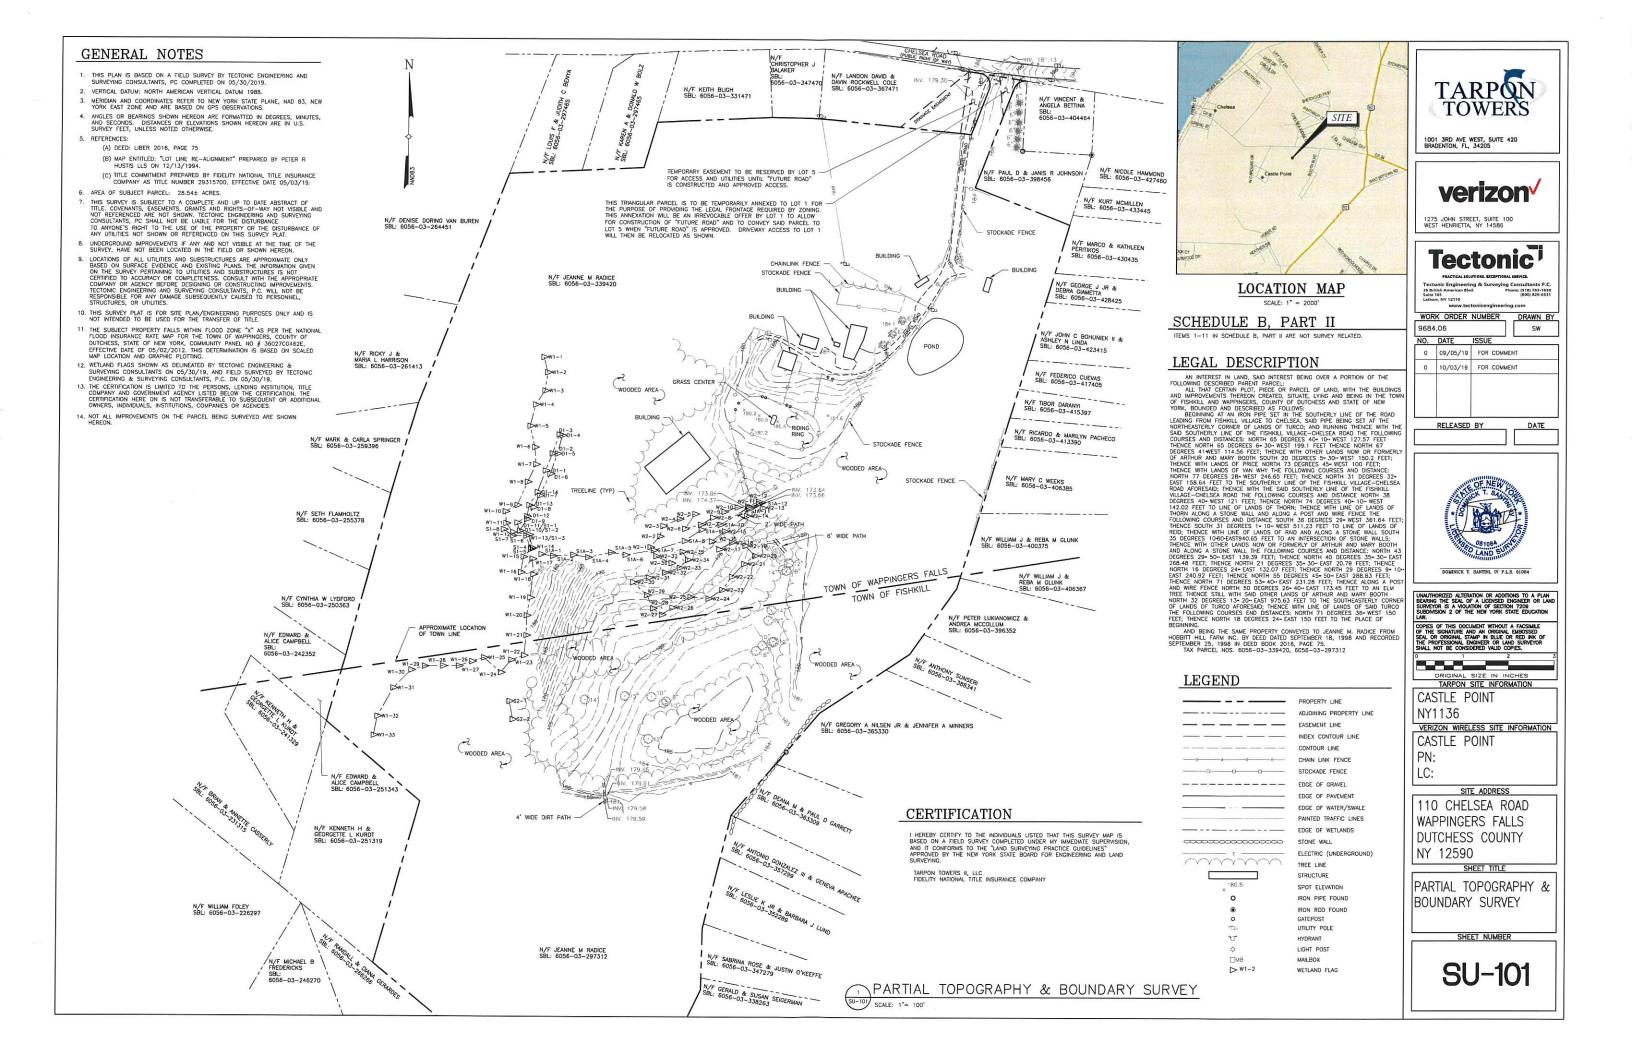




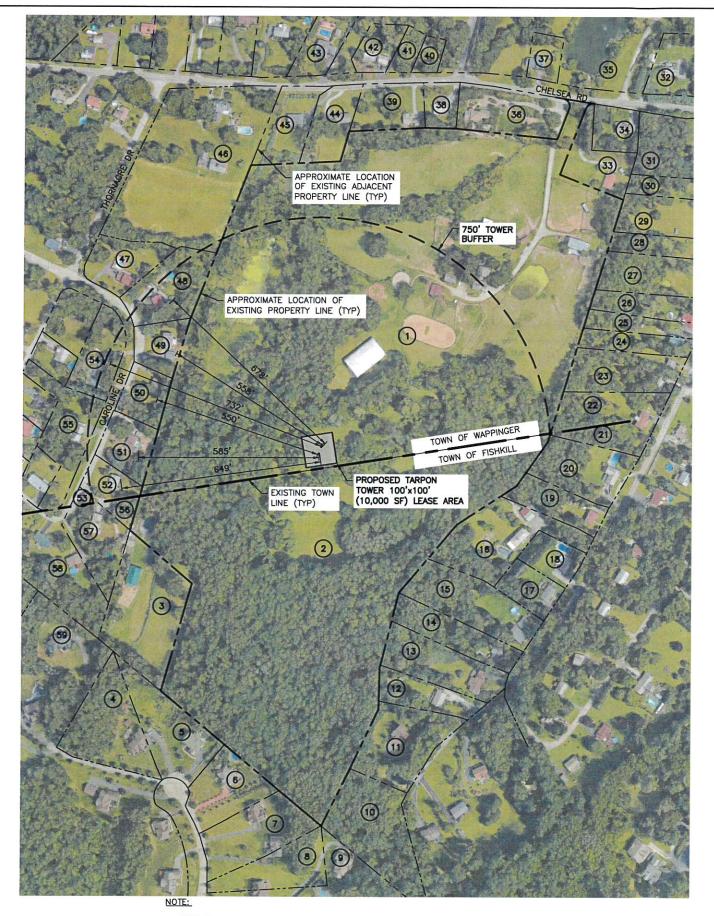

AUJADED	I cn	T SUBJECT STATE	
NUMBER	SBL	OWNER NAME	MAILING ADDR ESS
1	6056-03-339420	RADICE, JEANNE M	110 CHELSEA RD, WAPPINGERS FALLS, NY 12590
2	6056-03-297312	RADICE, JEANNE M	110 CHELSEA RD, WAPPINGERS FALLS, NY 12590
3	6056-03-251319	KURD T, KENNETH H	118 CAROLINE DR, WAPPINGERS FALLS, NY 12590
4	6056-03-246270	FREDERICKS, MICHAEL B	60 HUBER RD, WAPPINGERS FALLS, NY 12590
5	6056-03-266266	GERARDES, RANDALL	58 HUBER RD, WAPPINGERS FALLS, NY 12590
6	6056-03-280251	FLEMMING, COLIN	52 HUBER RD, WAPPINGERS FALLS, NY 12590
7	6056-03-291239	CHAN, WAI C	48 HUBER RD, WAPPINGERS FALLS, NY 12590
8	6056-03-295227	MELBOURNE, WAYNE	44 HUBER RD, WAPPINGERS FALLS, NY 12590
9	6056-03-326215	RUTTY, EMLYN P	36 NEDS WAY, WAPPINGERS FALLS, NY 12590
10	6056-03-329237	MCPARTLAND, DAVID G	81 WEST BOOTH BLVD, WAPPINGERS FALLS, NY 12590
11	6056-03-338263	SEIGERMAN, GERALD	76 WEST BOOTH BLVD, WAPPINGERS FALLS, NY 12590
12	6056-03-347279	ROSE, SABRINA	70 WEST BOOTH BLVD, WAPPINGERS FALLS, NY 12590
13	6056-03-352289	LUND, LESLIE K JR	68 WEST BOOTH BLVD, WAPPINGERS FALLS, NY 12590
14	6056-03-357299	GONZALEZ, ANTONIO III	66 WEST BOOTH BLVD, WAPPINGERS FALLS, NY 12590
15	6056-03-363309	GARRETT, DEANA M	60 WEST BOOTH BLVD, WAPPINGERS FALLS, NY 12590
16	6056-03-365330	NILSEN, GREGORY A JR	48 WEST BOOTH BLVD, WAPPINGERS FALLS, NY 12590
17	6056-03-382313	ALEXANDER, RICHARD JR	56 WEST BOOTH BLVD, WAPPINGERS FALLS, NY 12590
18	6056-03-389322	VALENTI, WILLIAM M & DIANE	52 WEST BOOTH BLVD, WAPPINGERS FALLS, NY 12590
19	6056-03-388341	SUNSERI, ANTHONY	46 WEST BOOTH BLVD, WAPPINGERS FALLS, NY 12590
20	6056-03-396352	LUKIANOWICZ, PETER	42 WEST BOOTH BLVD, WAPPINGERS FALLS, NY 12590
21	6056-03-406367	GLUNK, WILLIAM J TRUSTEE	32 WEST BOOTH BLVD, WAPPINGERS FALLS, NY 12590
22	6056-03-400375	GLUNK, WILLIAM J TRUSTEE	32 WEST BOOTH BLVD, WAPPINGERS FALLS, NY 12590
23	6056-03-406385	WEEKS, MARY C	
24	6056-03-413390	PACHECO, RICARDO & MARILYN	28 WEST BOOTH BLVD, WAPPINGERS FALLS, NY 12590
			26 BOOTH BLVD, WAPPINGERS FALLS, NY 12590
25	6056-03-415397	DARANYI, TIBOR	24 WEST BOOTH BLVD, WAPPINGERS FALLS, NY 12590
26	6056-03-417405	CUEVAS, FEDERICO	22 WEST BOOTH BLVD, WAPPINGERS FALLS, NY 12590
27	6056-03-423415	BOHUNIEK, JOHN C II	16 WEST BOOTH BLVD, WAPPINGERS FALLS, NY 12590
28	6056-03-428425	GIAMETTA, GEORGE J JR	14 WEST BOOTH BLVD, WAPPINGERS FALLS, NY 12590
29	6056-03-430435	PERITIKOS, MARCO	12 WEST BOOTH BLVD, WAPPINGERS FALLS, NY 12590
30	6056-03-433445	MCMILLEN, KURT	20 EAST MAIN ST, BEACON, NY 12590
31	6056-03-427460	HAMMOND, NICOLE	122 CHELSEA RD, WAPPINGERS FALLS, NY 12590
32	6056-03-427486	BETTINA, FRANK	119 CHELSEA RD, WAPPINGERS FALLS, NY 12590
33	6056-03-398456	JOHNSON, PAUL D	114 CHELSEA RD, WAPPINGERS FALLS, NY 12590
34	6056-03-404464	BETTINA, VINCENT	P.O. BOX 17, FISHKILL, NY 12590
35	6056-01-373534	CHELSEADHCLLC,	20 CORPORATE WOODS BLVD, WAPPINGERS FALLS, NY 12590
36	6056-03-367471	COLE, LANDONDAVID	106 CHELSEA RD, WAPPINGERS FALLS, NY 12590
37	6056-03-380488	BUCKLEY, DONOVAN F	109 CHELSEA RD, WAPPINGERS FALLS, NY 12590
38	6056-03-347470	BALAKER, CHRISTOPHER J	102 CHELSEA RD, WAPPINGERS FALLS, NY 12590
39	6056-03-331471	BLIGH, KEITH	98 CHELSEA RD, WAPPINGERS FALLS, NY 12590
40	6056-03-343488	BURGOS, DEYANIRA	12 COOKE CT, WAPPINGERS FALLS, NY 12590
41	6056-03-337489	DORE, MICHAEL	95 CHELSEA RD, WAPPINGERS FALLS, NY 12590
42	6056-03-326490	DORE, MICHAEL	95 CHELSEA RD, WAPPINGERS FALLS, NY 12590
43	6056-03-310495	BOUCHARD, JAMES G	91 CHELSEA RD, WAPPINGERS FALLS, NY 12590
44	6056-03-312468	BOLZ, KAREN A	94 CHELSEA RD, WAPPINGERS FALLS, NY 12590
45	6056-03-297465	BENYA, LOUIS F	90 CHELSEA RD, WAPPINGERS FALLS, NY 12590
46	6056-03-264451	VANBUREN, DENISEDORING	86 CHELSEA RD, WAPPINGERS FALLS, NY 12590
47	6056-03-244422	JANOS, KATHLEEN	102 CAROLINE DR, WAPPINGERS FALLS, NY 12590
48	6056-03-261413	HARRISON, RICKY J	102 CAROLINE DR, WAPPINGERS FALLS, NY 12590
48	6056-03-251413	SPRINGER, MARK	
50			108 CAROLINE DR. WARPINGERS FALLS, NY 12590
200	6056-03-255378	FLAMHOLTZ, SETH	110 CAROLINE DR, WAPPINGERS FALLS, NY 12590
51	6056-03-250363	LYDFORD , CYNTHIA W	114 CAROLINE DR, WAPPINGERS FALLS, NY 12590
52	6056-03-242352	CAMPBELL, EDWARD T	116 CAROLINE DR, WAPPINGERS FALLS, NY 12590
53	6056-03-234347	KURD T, KENNETH H	118 CAROLINE DR, WAPPINGERS FALLS, NY 12590
54	6056-03-238390	MERCHAN, LUIS	107 CAROLINE DR, WAPPINGERS FALLS, NY 12590
55	6056-03-227366	MANZI, KATHLEEN A LT	109 CAROLINE DR, WAPPINGERS FALLS, NY 12590
56	6056-03-251343	CAMPBELL, EDWARD	116 CAROLINE DR, WAPPINGERS FALLS, NY 12590
57	6056-03-241329	KURD T, KENNETH H	118 CAROLINE DR, WAPPINGERS FALLS, NY 12590
58	6056-03-231315	CASSERLY, BRIAN	122 CAROLINE DR, WAPPINGERS FALLS, NY 12590
59	6056-03-226297	FOLEY, WILLIAM	20 LEILA CT, WAPPINGERS FALLS, NY 12590



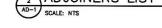





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CASTLE POINT VERIZON WIRELESS SITE INFORMATION

CASTLE POINT RE PN: 20191970954 LC: 295486

SITE ADDRESS

110 CHELSEA RD TOWN OF WAPPINGER DUTCHESS COUNTY NY 12401

ADJOINERS PLAN


SHEET NUMBER

AD-1

THE PROPERTY LINES HEREON ARE APPROXIMATE BASED ON GIS DATA AND ARE FOR ORIENTATION PURPOSES ONLY. THEY DO NOT REPRESENT A PROPERTY/BOUNDARY DECISION BY A LAND SURVEYOR.

1 ADJOINERS PLAN

AD-1 SCALE: 1" = 300' (11x17 SIZE)
1" = 150' (22x34 SIZE)

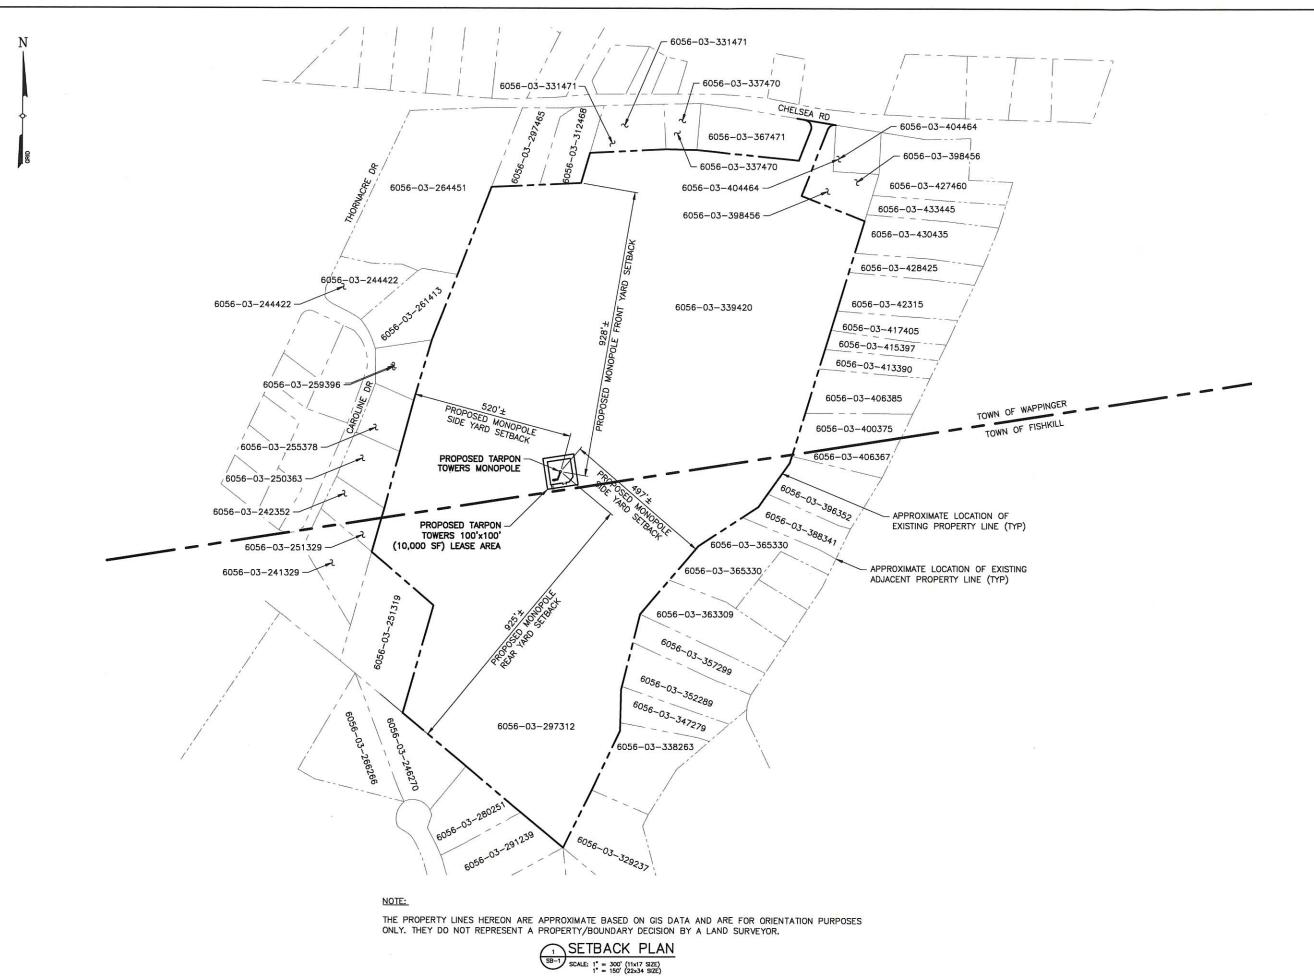





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ORIGINAL SIZE IN INCHES
TARPON SITE INFORMATION

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VERIZON WIRELESS SITE INFORMATION

| CASTLE POINT | RE PN: 20191970954 | LC: 295486

SITE ADDRESS


110 CHELSEA RD TOWN OF WAPPINGER DUTCHESS COUNTY NY 12401

SHEET TITLE

SETBACK PLAN

SHEET NUMBER

SB-1

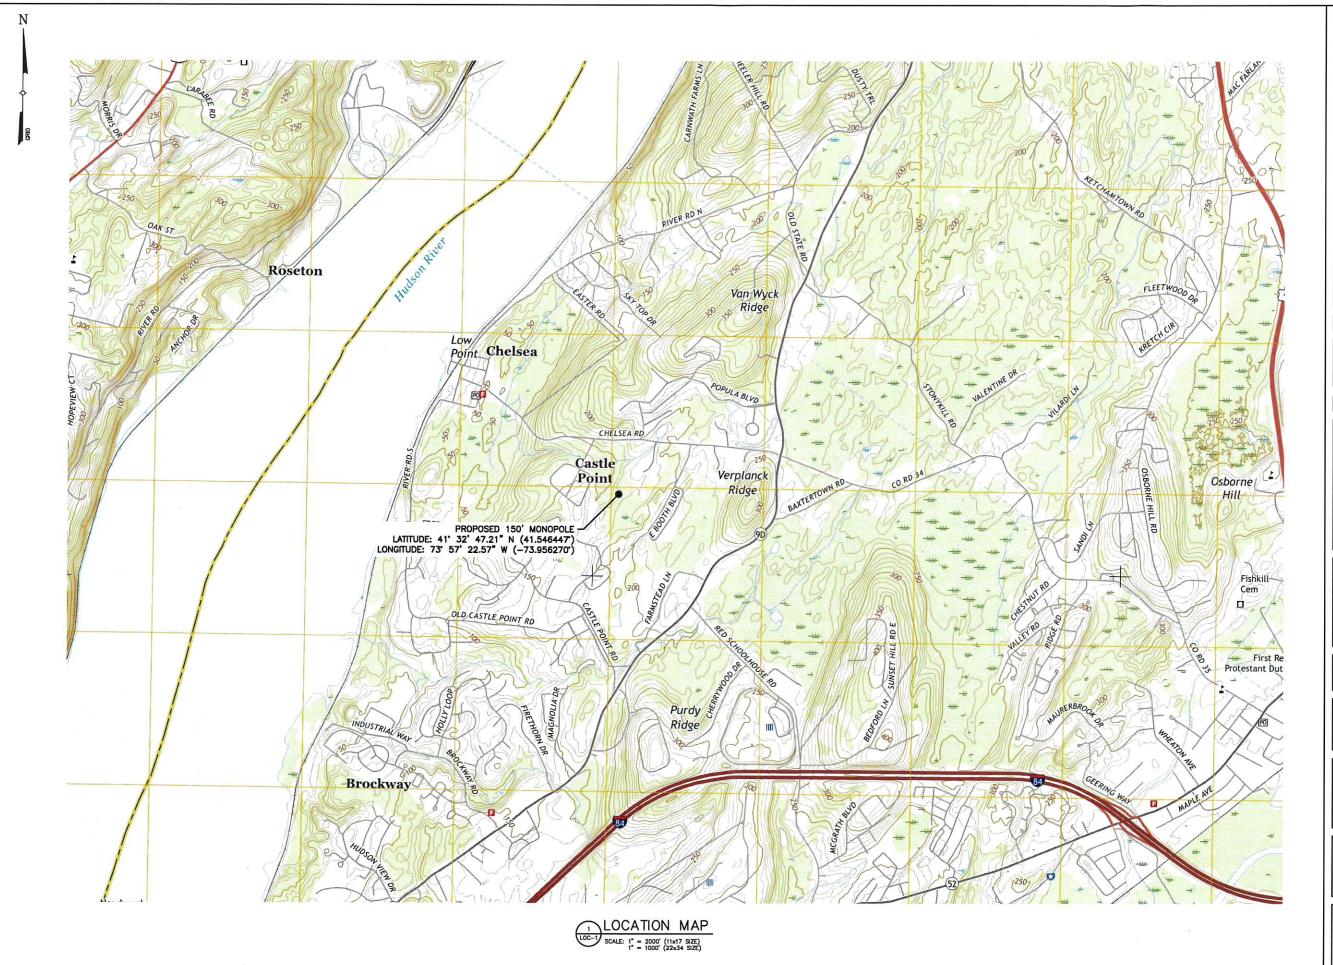



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ourtainville, NY 10983 www.tsctanlongineer

American Bivd.
NY 12110 Phone: (518)

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ORIGINAL SIZE IN INCHES
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CASTLE POINT
RE PN: 20191970954
LC: 295486

TOWN OF WAPPINGER DUTCHESS COUNTY NY 12401

SHEET TITLE

LOCATION MAP

SHEET NUMBER

LOC-1





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CASTLE POINT
VERIZON WIRELESS SITE INFORMATION
CASTLE POINT

RE PN: 20191970954 LC: 295486
SITE ADDRESS

110 CHELSEA RD TOWN OF WAPPINGER DUTCHESS COUNTY NY 12401


VICINITY MAP


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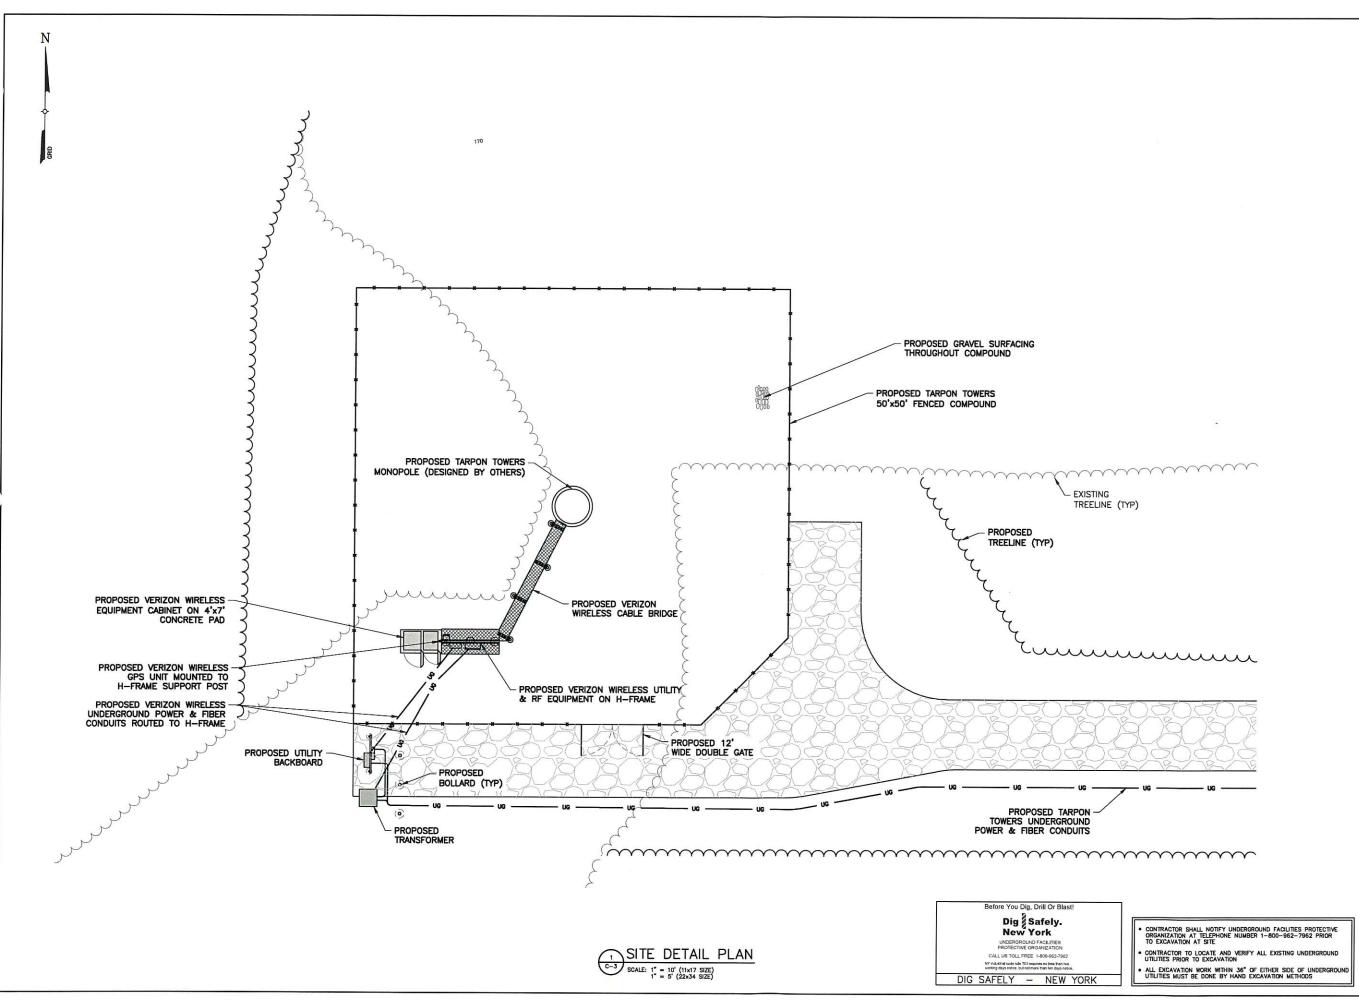
VIC-1

VICINITY MAP

SCALE: 1" = 400' (11x17 SIZE)
1" = 200' (22x34 SIZE)



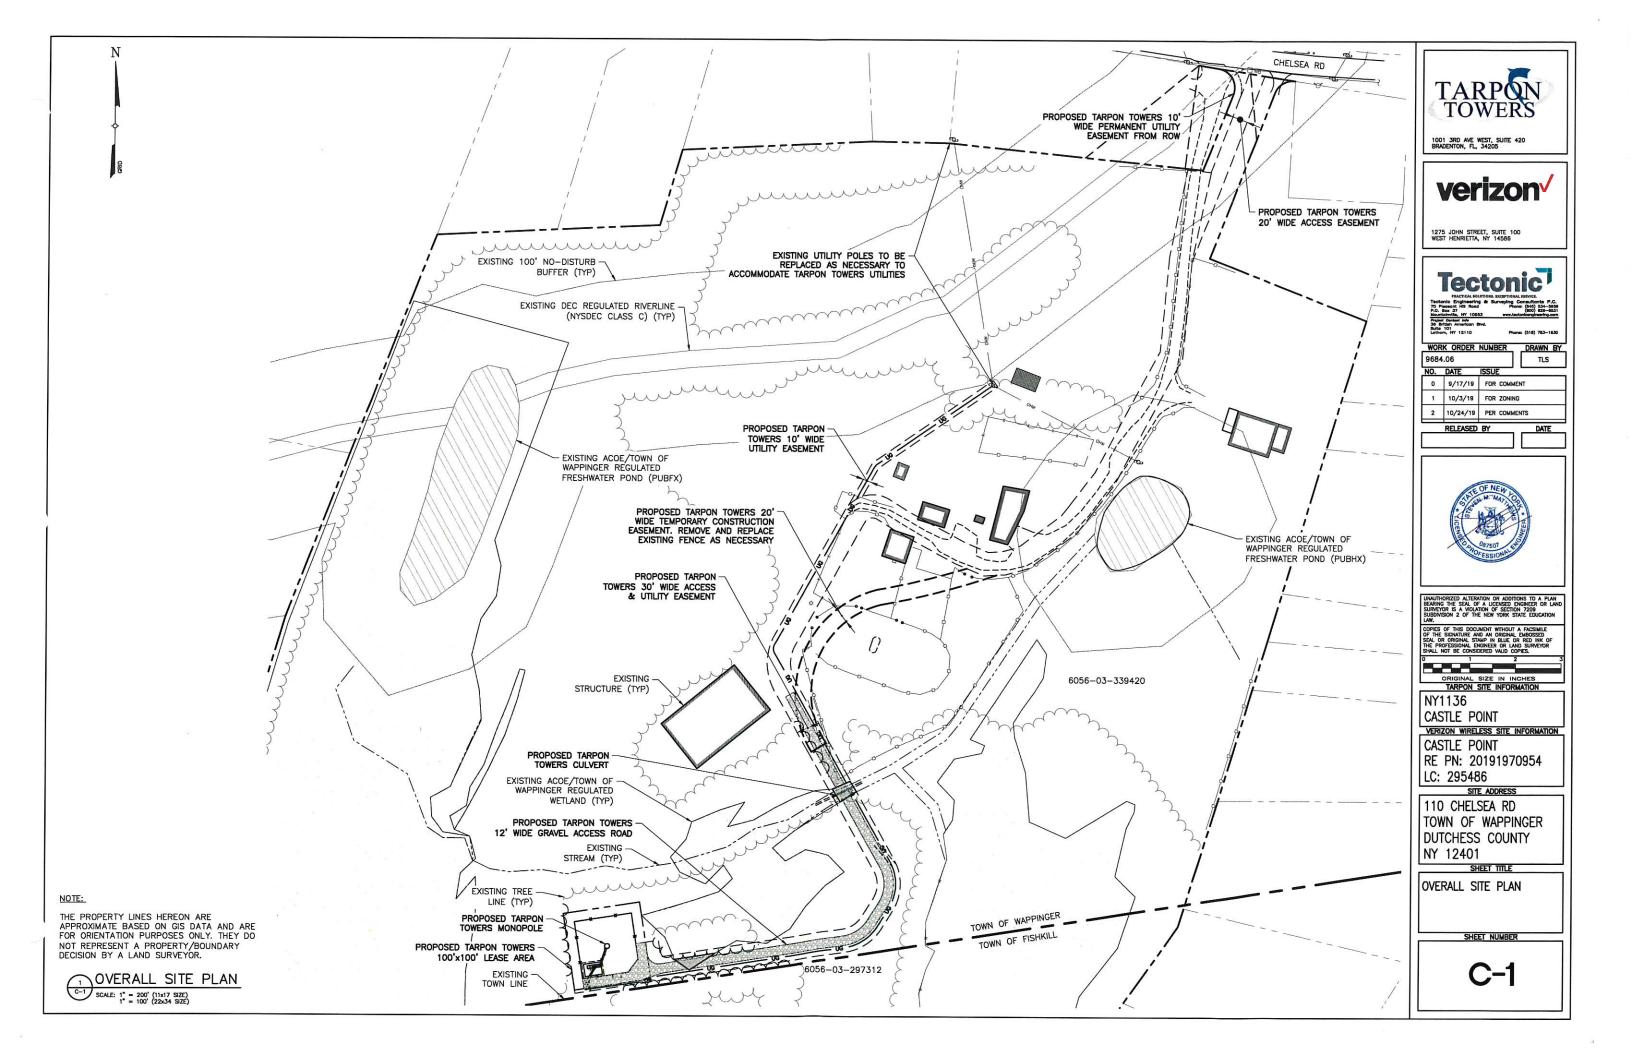

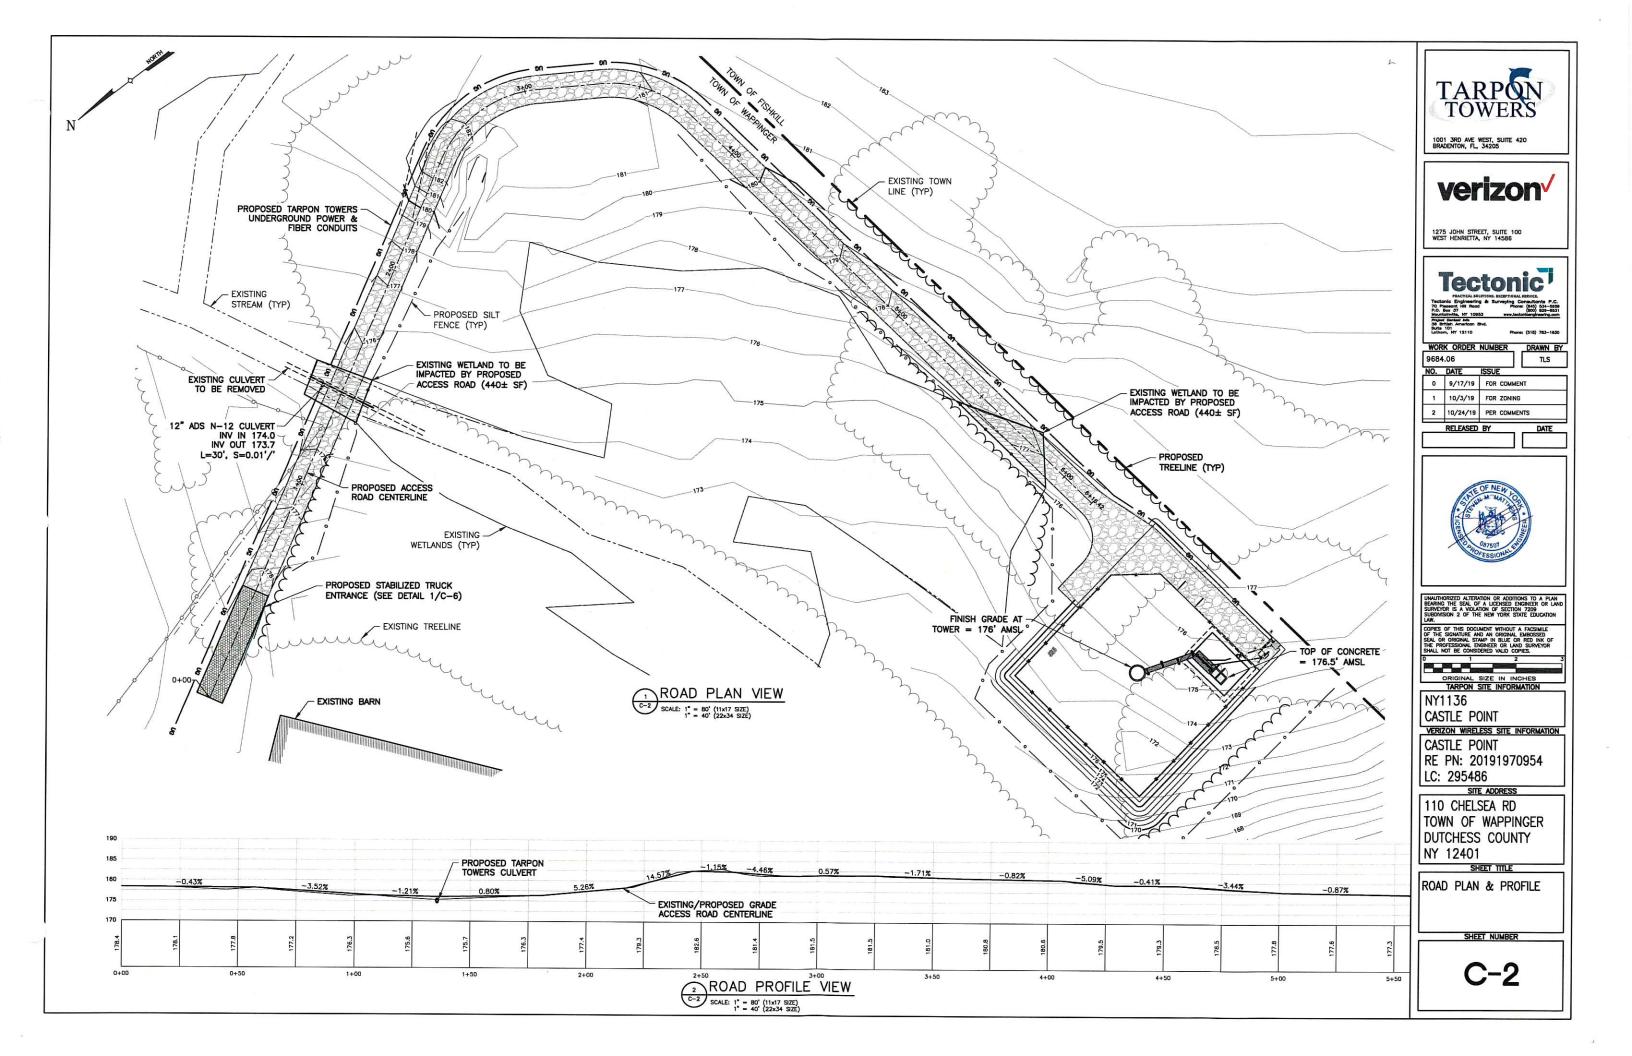



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CASTLE POINT RE PN: 20191970954 LC: 295486

SITE ADDRESS


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SHEET TITL

SITE DETAIL PLAN

SHEET NUMBER

C-3



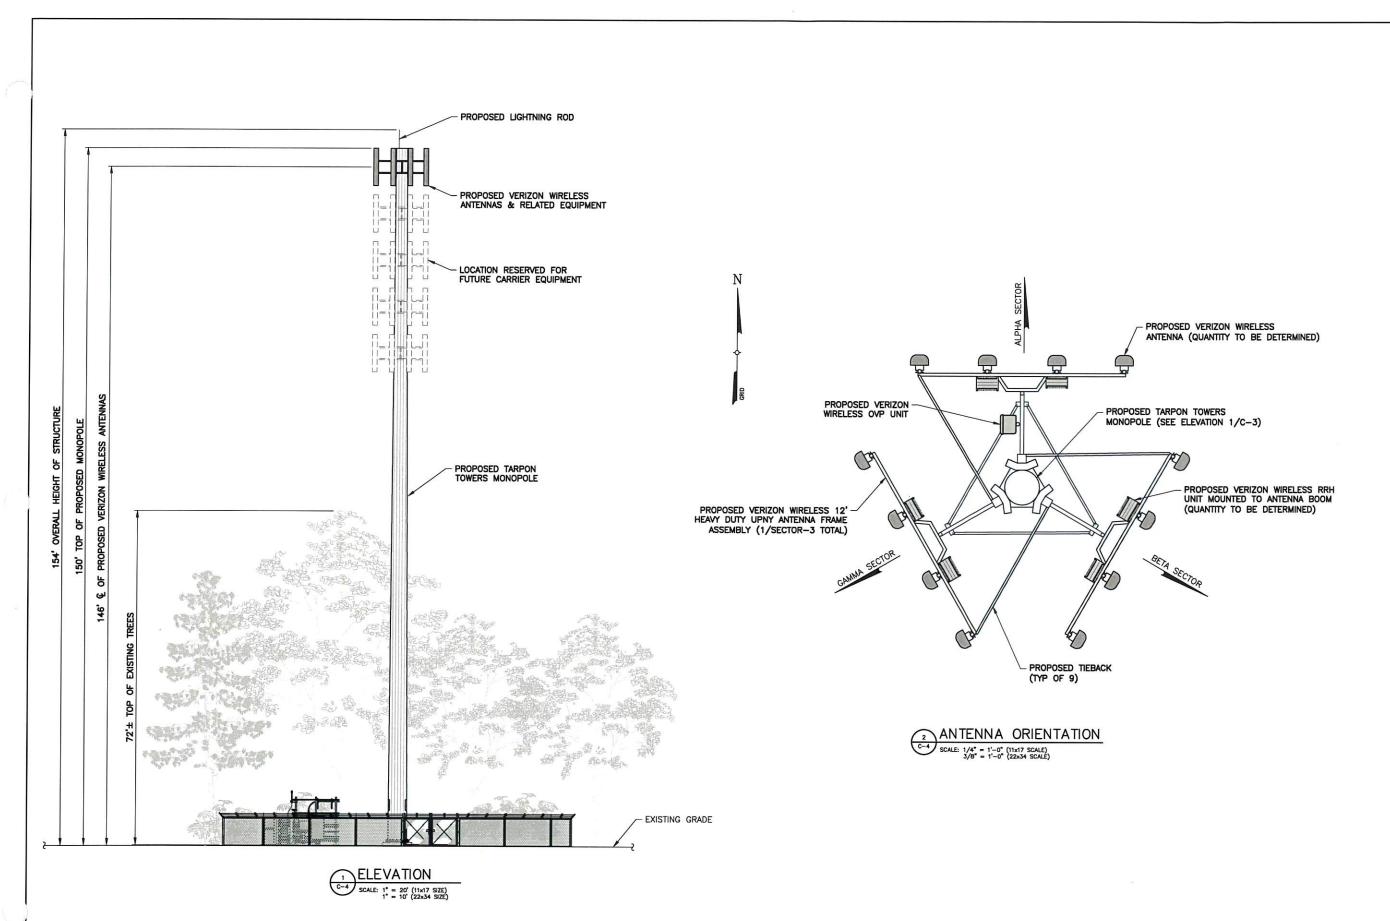



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CASTLE POINT RE PN: 20191970954

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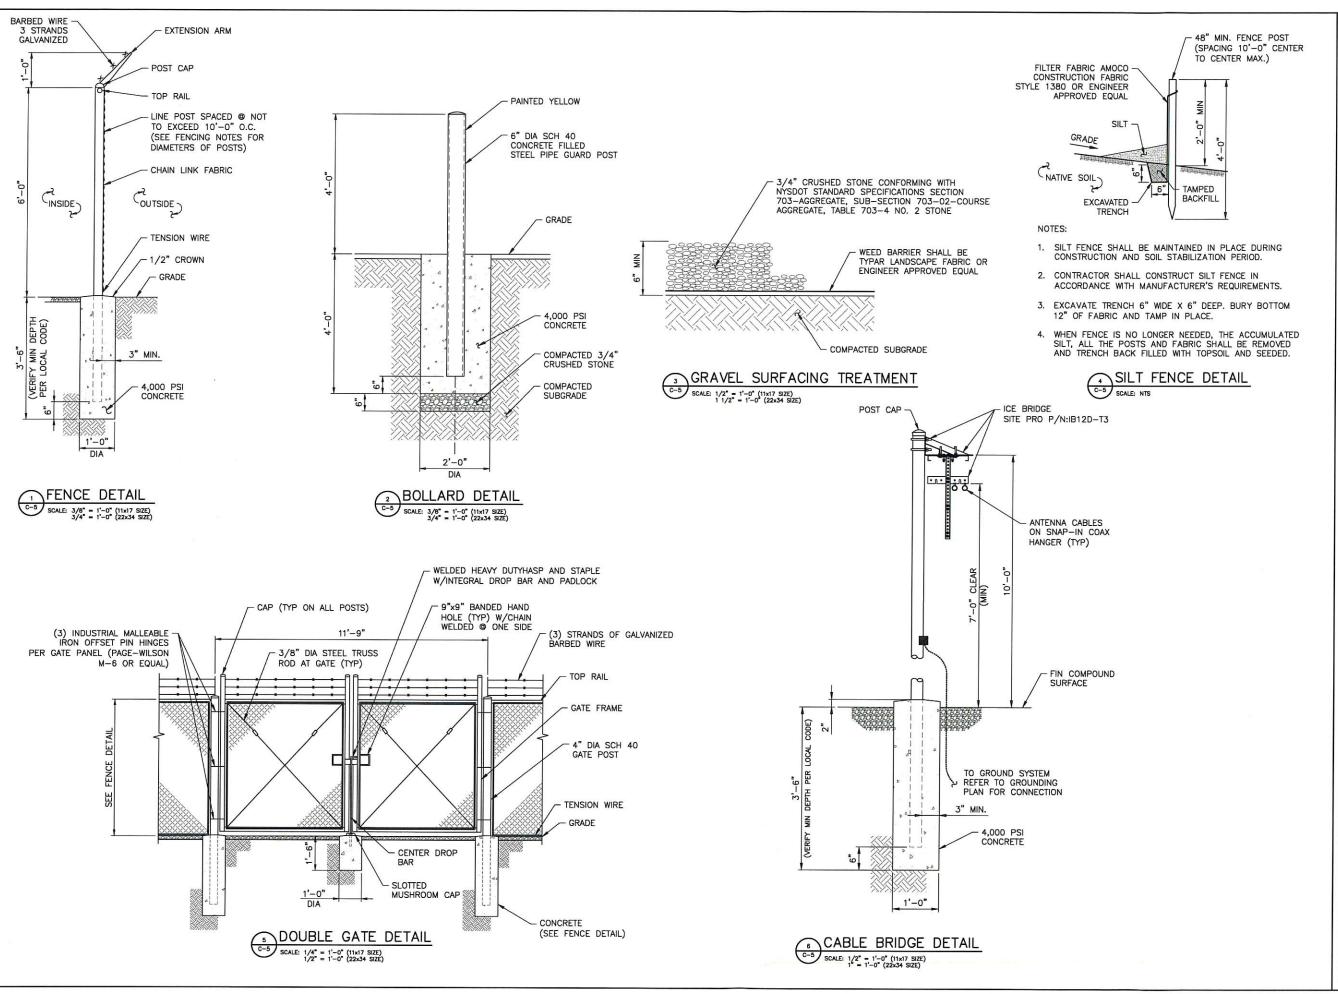
110 CHELSEA RD
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DUTCHESS COUNTY
NY 12401

SHEET TITLE

ELEVATION & ORIENTATION PLAN

SHEET NUMBER

C-4







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NY1136 CASTLE POINT

VERIZON WIRELESS SITE INFORMATION CASTLE POINT RE PN: 20191970954

LC: 295486


SITE ADDRESS 110 CHELSEA RD

TOWN OF WAPPINGER DUTCHESS COUNTY NY 12401


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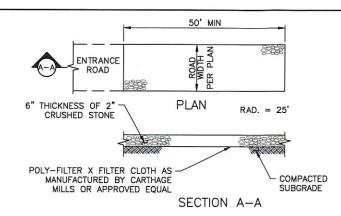
SITE DETAILS

SHEET NUMBER

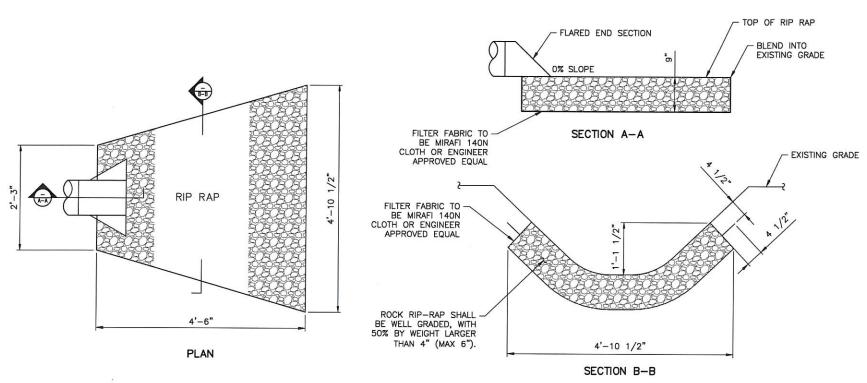

6" TOP COURSE CONFORMING




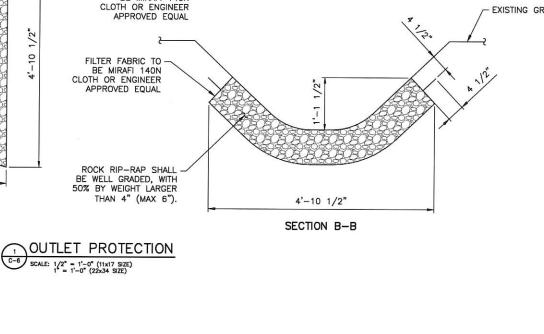

NOTES:

- STONE SIZE USE 2" STONE, OR RECLAIMED OR RECYCLED CONCRETE EQUIVALENT.
- LENGTH NOT LESS THAN 50 FEET 2.
- 3. THICKNESS - NOT LESS THAN SIX INCHES
- WIDTH 12 FOOT MINIMUM, BUT NOT LESS THAN THE FULL WIDTH AT POINTS WHERE INGRESS OR EGRESS OCCURS.
- FILTER CLOTH WILL BE PLACED OVER THE ENTIRE AREA PRIOR TO PLACING OF STONE.
- SURFACE WATER ALL SURFACE WATER FLOWING OR DIVERTED TOWARD CONSTRUCTION ENTRANCES SHALL BE PIPED ACROSS THE ENTRANCE. IF PIPING IS IMPRACTICAL A MOUNTABLE BERM WITH 5:1 SLOPES WILL BE PERMITTED.
- MAINTENANCE THE ENTRANCE SHALL BE MAINTAINED IN A CONDITION WHICH SHALL PREVENT TRACKING OR FLOWING OF SEDIMENT ONTO PUBLIC RIGHTS-OF-WAY, THIS MAY REQUIRE PERIODIC TOP DRESSING WITH ADDITIONAL STONE AS CONDITIONS DEMAND AND REPAIR AND/OR CLEANOUT OF ANY MEASURES USED TO TRAP SEDIMENT. ALL SEDIMENT SPILLED, DROPPED, WASHED, OR TRACKED ONTO PUBLIC RIGHTS-OF-WAY MUST BE
- WASHING WHEELS SHALL BE CLEANED TO REMOVE SEDIMENT PRIOR TO ENTRANCE ONTO PUBLIC RIGHTS—OF—WAY. IF ACCUMULATED SOIL DOES NOT COME OFF BY WAY OF STABILIZED CONSTRUCTION ENTRANCE, THE CONTRACTOR SHALL KNOCK OFF ACCUMULATED SOIL BY MANUAL METHODS UPSLOPE OF A SILT FENCE BARRIER.
- SEDIMENT TRAPPING SILT FENCE BARRIER SHALL BE INSTALLED DOWN SLOPE OF CONSTRUCTION ENTRANCE TO CATCH ANY SEDIMENT THAT COULD POTENTIALLY FALL OFF OF CONSTRUCTION EQUIPMENT AND/OR VEHICLES.
- PERIODIC INSPECTIONS AND NEEDED MAINTENANCE SHALL BE PROVIDED AFTER EACH RAIN.




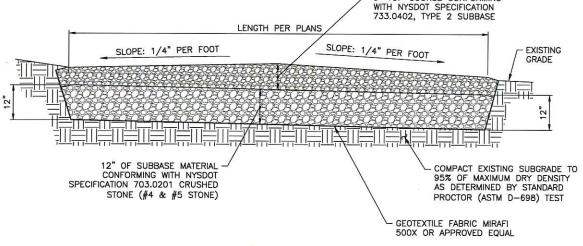

EARTH WORK SUBGRADE COMPACTION & SELECT GRANULAR FILL


- 1. CONTRACTOR SHALL BE RESPONSIBLE FOR CLEARING & GRUBBING THE CONSTRUCTION SITE AND ROADWAY AREAS. THE CONTRACTOR SHALL COMPLY WITH THE RECOMMENDATIONS CONTAINED WITHIN THE GEOTECHNICAL REPORT, AS PREPARED FOR THIS SITE, WHEN NECESSARY, FOR SITE WORK PREPARATION, & FOUNDATION WORK, AS A MINIMUM THE TOP 3" OF GRADE SHALL BE REMOVED, THE EXPOSED SUBGRADE COMPACTED AND GEOTEXTILE FABRIC INSTALLED AS REQUIRED FOR UNSTABLE SOIL CONDITION.
- 2. ALL SELECT GRANULAR FILL SHALL BE COMPACTED TO A 95% COMPACTION AT A MAXIMUM DRY DENSITY AS DETERMINED BY MODIFIED PROCTOR TEST (ASTM D-1557) AND WITHIN PLUS OR MINUS 3% OF OPTIMUM
- 3. CONTRACTOR TO ASSURE THAT EXISTING DRAINAGE PATTERNS ARE MAINTAINED.



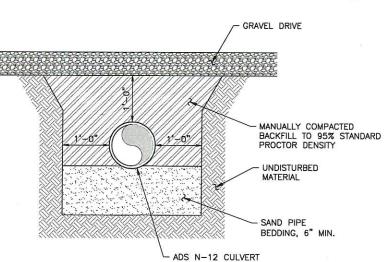


- 1. OVEREXCAVATE FOR BELLS.
- 2. ADDITIONAL BEDDING MAY BE USED AS ORDERED BY ENGINEER.
- 3. ALL EXCAVATION AND TRENCHING SHALL MEET OSHA REQUIREMENTS.



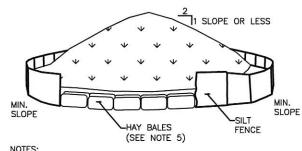

NOTES:

- 1. AREA CHOSEN FOR STOCKPILING OPERATIONS SHALL BE DRY AND
- 2. MAXIMUM SLOPE OF STOCKPILE SHALL BE 1V:2H.
- 3. UPON COMPLETION OF SOIL STOCKPILING, EACH PILE SHALL BE SURROUNDED WITH SILT FENCING, THEN STABILIZED WITH VEGETATION OR COVERED
- 4. SEE SPECIFICATIONS FOR INSTALLATION OF SILT FENCE.
- 5. HAYBALES TO BE USED WHERE STOCKPILES ARE LOCATED ON PAVED AREAS.

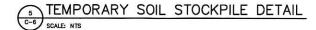



1001 3RD AVE WEST, SUITE 420 BRADENTON, FL, 34205



1275 JOHN STREET, SUITE 100 WEST HENRIETTA, NY 14586



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TARPON SITE INFORMATION

NY1136 CASTLE POINT VERIZON WIRELESS SITE INFORMATION

CASTLE POINT RE PN: 20191970954 LC: 295486

SITE ADDRESS 110 CHELSEA RD TOWN OF WAPPINGER DUTCHESS COUNTY NY 12401

SHEET TITLE

SITE DETAILS

SHEET NUMBER



6-port sector antenna, 2x 698-896 and 4x 1695-2360 MHz, 65° HPBW, 2x RET. Both high bands share the same electrical tilt.

- Interleaved dipole technology providing for attractive, low wind load mechanical package
- . Internal SBT on low and high band allow remote RET control from the radio over the RF jumper cable.
- One RET for low band and one RET for both high bands to ensure same tilt level for 4x Rx or 4x MIMO

Electrical Specifications

Frequency Band, MHz	698-806	806-896	1695-1880	1850-1990	1920-2200	2300-2360
Gain, dBi	16.0	16.1	17.3	17.7	18.3	18.2
Beamwidth, Horizontal, degrees	65	62	74	66	62	59
Beamwidth, Vertical, degrees	9.0	7.9	5.6	5.2	4.9	4.5
Beam Tilt, degrees	0-11	0-11	0-7	0-7	0-7	0-7
USLS (First Lobe), dB	21	18	19	20	22	18
Front-to-Back Ratio at 180°, dB	35	31	33	29	29	30
Isolation, Cross Polarization, dB	25	25	25	25	25	25
Isolation, Inter-band, dB	30	30	30	30	30	30
VSWR Return Loss, dB	1.5 14 0	1.5 14.0	15 14.0	1.5 14.0	1.5 14 0	1.5 14 0
PIM, 3rd Order, 2 x 20 W, dBc	-153	-153	-153	-153	-153	-153
Input Power per Port, maximum, watts	400	400	350	350	350	300
Polarization	±45"	±45°	±45°	±45°	±45°	±45°
Impedance	50 chm	50 chm	50 ohm	50 ohm	50 ohm	50 ohm
Electrical Specifications,	BASTA*					
Frequency Band, MHz	698-806	806-896	1695-1880	1850-1990	1920-2200	2300-2360
Gain by all Beam Tilts, average, dBi	15.8	15.9	16.9	17.5	18.0	179
Gain by all Beam Tilts Tolerance, dB	±0.4	±0.4	±0.4	±0.3	±0.6	±0.4
	0 * 15.9	0 * 15.8		0 " 17.4	0 * 17.9	0 = 1 17.8
Gain by Beam Tilt, average, dBi	5 ° 15.9	5 * 16.0		4 0 17.5	4 0 18.0	4 = 17.9
Beamwidth, Horizontal Tolerance,	±1.2	11 * 15.7 ±1.6	7" 16.9 ±5.3	7° 17.4 ±3.4	7 ° 16.0 ±6	7 * 17.9 ±3.1
degrees Beamwidth, Vertical Tolerance, degrees	±0.6	±0.4	±0.3	±0.2	±0.2	±0.2
JSLS, beampeak to 20" above beampeak, dB	15	14	17	16	17	15
ront-to-Back Total Power at 180° ± 30°, dB	26	24	28	25	25	24
				100.00		2.47
CPR at Boresight, dB	18	26	20	25	20	17

CownScope® supports NGMN recommen whitepaper Time to Raise the Bar on BSAs.

2x RETs and 2x SBTs. Both high bands share the same electrical tilt.

Separate RS-485 RET input/output for low and high band

1.5 | 14.0 -153

+0.5

±1.8

28

1.5 J 14.0 -153

+0.2

±2.7

25

+0.4

Narrow beamwidth capacity antenna for higher level of densification and enhanced data throughout

Internal SBT on low and high band allow remote RET control from the radio over the RF jumper cable.

One LB RET and one HB RET. Both high bands are controlled by one RET to ensure same tilt level for 4.

1.5 | 14.0 -153

-0.4

±1.9

±0.3

±1.6

32

Array Layout

NHH-45C-R2B

- 5 5 0 0 4 6 ·

Electrical Specifications

Frequency Band, MHz Gain, dBi Beamwidth, Horizontal, degrees

Beamwidth, Vertical, degrees

Front-to-Back Ratio at 180°, dB

Isolation, Cross Polarization, dB

Electrical Specifications, BASTA*

Frequency Band, MHz Gain by all Beam Tilts, average, dBi Gain by all Beam Tilts Tolerance,

Beamwidth, Honzontal Tolerance,

degrees Beamwidth, Vertical Tolerance, degrees USLS, beampeak to 20° above beampeak, dB

Front-to-Back Total Power at 180° ± 30°, dB

* CommScope® supports NGMN recommen whitesacer Time to Raise the Bar on BSAs.


Beam Tilt, degrees USLS (First Lobe), dB

Isolation, Inter-band, dB Isolation, Inter-band, dB VSWR | Return Loss, dB PRM, 3rd Order, 2 x 20 W, dBc Input Power per Port, maximum, watts Polarization Impedance

COMMSCOPE"

page 1 of 5 October 2, 2019

NHH-65C-R2B

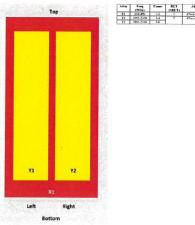

View from the front of the antenna (Sizes of colored boxes are not true depictions of array sizes)

General Specifications Operating Frequency Band

1695 - 2360 MHz | 698 - 896 MHz

NHH-65C-R2B

170.2 lbf 6 150 km/n | 1 757 0 N @ 150 km/n

Mechanical Specifications

RF Connector Quantity, total RF Connector Quantity, low band

RF Connector Interface 7-16 DIN Female Color

Light gray

RF connector body grounded to reflector and mounting bracket

Copper | Low loss circuit board Radome Material

Reflector Material Aluminum RF Connector Location

Wind Loading, frontal 393.0 N @ 150 km/h | 88.8 lbf @ 150 km/h Wind Loading, lateral 330.0 N @ 150 km/h | 74.2 lbf @ 150 km/h

0.37 m² | 3.98 ft² Effective Projected Area (EPA), lateral 0.31 m² | 3.34 ft² Wind Speed, maximum

Wind Loading, maximum

NHH-45C-R2B

General Specifications

Operating Frequency Band Antenna Type

Total Input Power, maximum

RF Connector Quantity, total

RF Connector Interface

Grounding Type

Reflector Material RF Connector Location Wind Loading, frontal

Wind Loading, lateral

Dimensions

Length

Wind Loading, maximum

Effective Projected Area (EPA), fronta

Effective Projected Area (EPA), latera

Net Weight, without mounting kit

Remote Electrical Tilt (RET) Information

Mechanical Specifications

RF Connector Quantity, high band

2438.0 mm | 96.0 in 301.0 mm | 11.9 in

23.4 kg | 51.6 lb

Remote Electrical Tilt (RET) Information

Input Voltage 10-30 Vdc Internal Bias Tee Port 1 | Port 3 High band (1) | Low band (1)

Power Consumption, idle state, maximum Power Consumption, normal conditions, maximum 13 $\ensuremath{\mathrm{W}}$

3GPP/AISG 2.0 (Single RET) RET Interface 8-pin DIN Female | 8-pin DIN Male

2 female | 2 male

page 3 of 5 October 2, 2019

COMMSCOPE"

Classification Compliant by Exemption Designed, manufactured and/or distributed under this quality management system Above Maximum Concentration Value (MCV)

NHH-65C-R2B

Packed Dimensions

Length

Shipping Weight





Regulatory Compliance/Certifications

Included Products

BSAMNT-3 — Wide Profile Antenna Downtilt Mounting Kit for 2.4 - 4.5 in (60 - 115 mm) OD round members. Kit contains one scissor top

2 female | 2 male

2579.0 mm | 101.5 m

608.0 mm 23.9 m

346.0 mm 13.6 m

2561.0 mm | 1 100.8 in

409.0 mm 16 1 in 299.0 mm 11.8 in

36 1 kg | 79.6 lb

* Footnotes

NHH-45C-R2B

RET Interface, quantity

Packed Dimensions

iso 🚳

Included Products

* Footnotes

Regulatory Compliance/Certifications

Classification

Compliant by Exemption

Performance Note Severe environmental conditions may degrade optimum performance

Above Maximum Concentration Value (MCV)

BSAMNT-M — Middle Downtilt Mounting Kit for Long Antennas for 2.4 - 4.5 in (60 - 115 mm) OD round members. Kit contains one

BSAMNT-3 — Wide Profile Antenna Downtilt Mounting Kirl for 2.4 + 4.5 in (60 - 115 mm) OD round members. Kirl contains one scissor top bracket set and one bottom bracket set

Severe environmental conditions may degrade optimum performance

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TARPON SITE INFORMATION

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CASTLE POINT VERIZON WIRELESS SITE INFORMATION

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LC: 295486 SITE ADDRESS

110 CHELSEA RD TOWN OF WAPPINGER DUTCHESS COUNTY NY 12401


SHEET TITLE

ANTENNA SPECIFICATIONS

SHEET NUMBER

NHH-45C-R2B

port sector antenna, 2x 698–896 and 4x 1695–2360 MHz, 45° HPBW, Array Layout

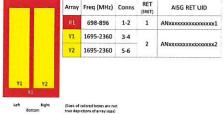

		Array	Freq (MHz)	Conns	RET (SRET)	AISG RET UID
		R1	698-896	1-2	1	ANxxxxxxxxxxxxxxxxxxxxxxxxxxxxxxxxxxxx
		Y1	1695-2360	3-4		200
		Y2	1695-2360	5-6	2	ANxxxxxxxxxxxxxxxxxx2
Y1	Y2					
9	1					
Left	Right	(Sizes of	colored boxes are no	at		

Port Configuration



Input Voltage

Internal RET

8-pin DIN Female | 8-pin DIN Male

COMMSCOPE"

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COMMSCOPE"

1.5 | 14.0 -153

±0.3

±2.1

High band (1) | Low hand (1)

3GPP/AISG 2 0 (Single RET)

COMMSCOPE'

COMMSCOPE"

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1695 - 2360 MHz | 698 - 896 MHz

RF connector body prounded to reflector and mounting bracket

315.0 N @ 150 km/h 1,485.0 N @ 150 km/h | 333.8 N @ 150 km/h

Multiband

800 W @ 50 °C

4.3-10 Female

Fiberglass, UV resistant

1,485.0 N @ 150 km/h

1.40 m² | 15.07 ft²

241 km/h | 150 mph

2437.0 mm | 95.9 in

457.0 mm | 18.0 in 178.0 mm | 7.0 in


39.5 kg | 87 l lb

10-30 Vdc Port 1 | Port 3

Light gray

COMMSCOPE"

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AGRICULTURAL DATA STATEMENT

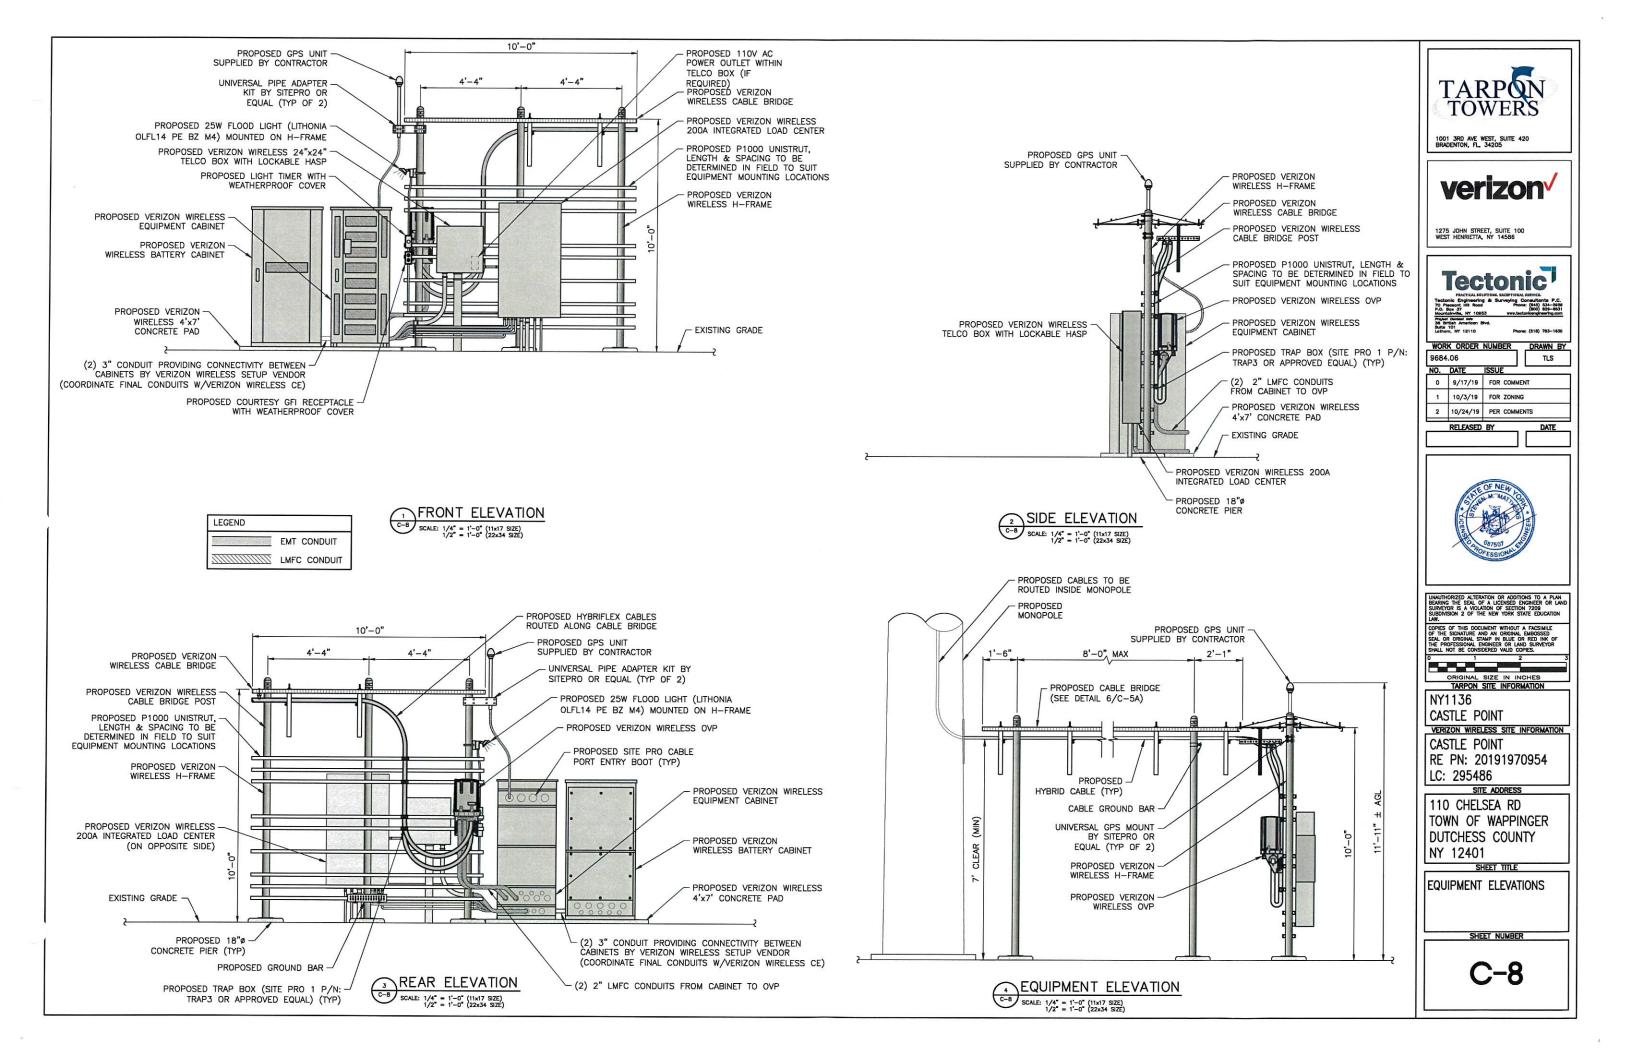Per § 305-a of the New York State Agriculture and Markets Law, any application for a special use permit, site plan approval, use variance, or subdivision approval requiring municipal review and approval that would occur on property within a New York State Certified Agricultural District containing a farm operation or property with boundaries within 500 feet of a farm operation located in an Agricultural District shall include an Agricultural Data Statement.

A.	Name of applicant: Mailing address:	Tarpon Towers II, LLC		
		1001 3rd Ave West, Suite	420	_
		Brandenton, FL 34205		- 2
B.		posed project: Wireless te over letter, dated October 9, 20		
С.	Project site address:	110 Chelsea Road	Town: <u>V</u>	/appinger
D.	Project site tax map number: 6056-03-339420			
E:	The project is located on property: within an Agricultural District containing a farm operation, or with boundaries within 500 feet of a farm operation located in an Agricultural District.			
F.	Number of acres affected by project: 0.55			
G.	. Is any portion of the project site currently being farmed? Horse farm ✓ Yes. If yes, how many acres 47.91 or square feet ? □ No.			
		any owner of land containi eet of the boundary of the p		
Jea	nne M Radice, Landlo	rd		
110) Chelsea Road, Wa _l	ppingers Falls, NY 12590		
I. of fa	Attach a copy of the carm operations identifie	urrent tax map showing the ed in Item H above. See sit	site of the proposed proje e plan drawings, sheet SB-1d	ct relative to the location dated 10/24/19
~ ~ ′	~ ~ ~ ~ ~ ~ ~ ~ ~ ~ ~ ~ ~ ~ ~ ~	FARM I		~~~~~~~~~~~~~
othe or re	r conditions that may be	be aware that farm operation objectionable to nearby propertionable to nearby propertion. State Certified Agricultures	erties. Local governments sh	all not unreasonably restrict
/	Vill A. All	AAMMer /AG		

Neil J. Alexander, Esq., Attorney for the Applicant